

Steven L. Beshear Governor Frankfort, Kentucky 40622 www.transportation.ky.gov/

Michael W. Hancock, P.E. Secretary

August 11, 2014

CALL NO. 102

CONTRACT ID NO. 141041

ADDENDUM # 1

Subject:

Pulaski County, HSIP 5105 (035)

Letting August 22, 2014

(1) Revised - Plans - R1, R2, R2A, R2B, R3, R5, R11, & X14

(2) Added - Special Notes - Pages 17(a)-17(c) of 105

(3) Revised - Bid Items - Pages 104-105 of 105

Plan revisions are available at http://www.lynnimaging.com/kytransportation/.

If you have any questions, please contact us at 502-564-3500.

Sincerely,

liana Castle Padolifle
Diana Castle Radoliffe

Director

Division of Construction Procurement

DR:ks

Enclosures



# **REVISED 8-11-14**

SHEET NO. 8-926.00 PULASKI



# PULASKI COUNTY KY 70 IMPROVEMENTS AT BUCK CREEK HSIP 5105 (035) FD52 100 0070 009-010

EUBANK STA. 25+00.0 END PROJECT STA. 18+82.27 CONSTRUCT 9 LF √STA. 5+00.0 BEGIN PROJECT

THIS PROJECT IS OFF THE NH SYSTEM

THESE PLANS ARE FOR GRADE, DRAIN, & SURFACING

12' x 6' RCBC EXTENSION

THE CONTROL OF ACCESS ON THIS PROJECT SHALL BE BY PERMIT

# SCALE IN FEET

## LAYOUT MAP

											PROJECT HSIP NUMBER:
		I									LETTING DATE:
FT. <u>0.379</u>			LIN. FT			LIN. FT		LENGTH	LIN. FT	MILES	
ES	LIN. FT.	ADDED	FOR EQUALITIES	LIN. FT.	ADDED T	— FOR EQUALITIES	LIN. FT.	ADDED	FOR EQUALITIES	LIN. FT.	
NCLUDED		_	NOT INCLUDED		_	NOT INCLUDE	D	_	NOT INCLUDED		RECOMMENDED BY:
			CROSSINGS NO	LIN. FT.	RAILROAD	CROSSINGS NO	LIN. FT.	RAILROAD	CROSSINGS NO	LIN. FT.	
	LIN. FT.	BRIDGES _		LIN. FT.	BRIDGES		LIN. FT.	BRIDGES _		LIN. FT.	
											PLAN APPROVED BY:
		I									1

#### Commonwealth of Kentucky DEPARTMENT OF HIGHWAYS **COUNTY OF**

### **PULASKI**

ITEM NO.	8-926	.00		
	HSIP	5105 (035)		
PROJECT NUMBER:	FD52	100 0070 009-010		
LETTING				
RECOMMENDED	RY:	BRIAN DUNBAR	DATE:	6-4-14
.233211020	J.,	PROJECT MANAGER		
		m Mo		

DATE: **7-11-2014** 

NUMBER

RBI-002-06 RBI-004-04 RBR-010-05 RBR-015-04 RBR-016-04

RDB-105-05 RDB-106-04

TOTAL STANDARD DRAWINGS: 18

DESIGN SPEED REQUIRED NPSD N/A REQUIRED PSD LEVEL OF SERVICE N/A ADT PRESENT ( 2011 ) 1,081 ADT FUTURE ( ---- ) \_\_\_\_ DHV N/A D % N/A

LATITUDE 37 DEGREES 16 MINUTES 33 SECONDS NORTH LONGITUDE 84 DEGREES 34 MINUTES 13 SECONDS WEST

T % 9.7%

**DESIGNED** % RESTRICTED SD LEVEL OF SERVICE MAX. DISTANCE W/O PASSING

GEOGRAPHIC COORDINATES

**DESIGN CRITERIA** 

CLASS OF HIGHWAY RURAL MINOR COLLECTOR

N/A

TYPE OF TERRAIN ROLLING

STANDARD DRAWINGS

RDI-020-08

RPM-110-06

**DED STANDARD DRAWING RDX-225** 

**BEFORE YOU DIG** 

The contractor is instructed to call 1-800-752-6007 to reach KY 811, the one-call system for information on the location of existing underground utilities. The call is to be placed a minimum of two (2) and no more than ten (10) business days prior to excavation. The contractor should be aware that owners of underground facilities are not required to be members of the KY 811 one-call Before-U-Dig (BUD) service. The contractor must coordinate excavation with the utility owners, including those whom do not subscribe to KY 811. It may be necessary for the contractor to contact the County Court Clerk to determine what utility companies have facilities in the area.

LENGTH **2,000.00** LIN. F<sup>-</sup> ADDED FOR EQUALITIES RAILROAD CROSSINGS NO. \_ RIDGES \_\_\_

DESCRIPTION SHEET NO. TYPICAL SECTIONS R2 R2A R2B R3 - R6 SUMMARY OF QUANTITIES GENERAL NOTES ENTRANCE PROFILES TRAFFIC CONTROL NOTES SEPIA - DELINEATORS FOR GUARDRAI SEPIA - GUARDRAIL COMMONENTS
SEPIA - CENTERLINE RUMBLE STRIPS
SEPIA - GUARDRAIL STEEL W-BEAM
SEPIA - GUARDRAIL POSTS R15 R16

S1 - S8 STRUCTURE PLANS CROSS SECTION SHEETS X1 - X17

SHEETS NOT INCLUDED IN TOTAL SHEETS

R2A - R2B

#### STANDARD DRAWINGS

#### **NUMBER**

RDI-020-08 RBI-002-06 RBI-004-04 RBR-010-05 RBR-015-04 RGX-010-03 RBR-016-04 RBR-020-05 RPM-110-06 RDB-105-05 TPM-150 RDB-106-04 RDX-225

TOTAL STANDARD DRAWINGS: 18

#### **BEFORE YOU DIG**

The contractor is instructed to call 1-800-752-6007 to reach KY 811, the one-call system for information on the location of existing underground utilities. The call is to be placed a minimum of two (2) and no more than ten (10) business days prior to excavation. The contractor should be aware that owners of underground facilities are not required to be members of the KY 811 one-call Before-U-Dig (BUD) service. The contractor must coordinate excavation with the utility owners, including those whom do not subscribe to KY 811. It may be necessary for the contractor to contact the County Court Clerk to determine what utility companies have facilities in the area.

#### **DESIGN CRITERIA**

CLASS OF HIGHWAY RURAL MINOR COLLECTOR TYPE OF TERRAIN ROLLING DESIGN SPEED REQUIRED NPSD N/A N/A REQUIRED PSD LEVEL OF SERVICE N/A ADT PRESENT ( 2011 ) 1,081 ADT FUTURE ( ---- ) \_\_\_\_ DHV N/A D % N/A T % 9.7% GEOGRAPHIC COORDINATES

LATITUDE 37 DEGREES 16 MINUTES 33 SECONDS NORTH LONGITUDE 84 DEGREES 34 MINUTES 13 SECONDS WEST

#### **DESIGNED**

% RESTRICTED SD
LEVEL OF SERVICE
MAX. DISTANCE W/O PASSING

# Commonwealth of Kentucky DEPARTMENT OF HIGHWAYS

PLANS OF PROPOSED PROJECT

PULASKI COUNTY KY 70 IMPROVEMENTS AT BUCK CREEK HSIP 5105 (035) FD52 100 0070 009-010

> EUBANK STA. 25+00.0 END PROJECT STA. 18+82.27 CONSTRUCT 9 LF 12' × 6' RCBC EXTENSION

THIS PROJECT IS OFF THE NH SYSTEM

THESE PLANS ARE FOR GRADE, DRAIN, & SURFACING

√STA. 5+00.0 BEGIN PROJECT

LAN APPROVED BY:

THE CONTROL OF ACCESS ON THIS PROJECT SHALL BE BY PERMIT



## LAYOUT MAP

#### LENGTH <u>2.000.00</u> LIN. FT. <u>0.379</u> MILES LENGTH LIN. FT. MILES LENGTH LENGTH ADDED FOR EQUALITIES \_\_\_\_\_LIN. FT. ADDED FOR EQUALITIES \_\_\_\_\_LIN. FT. ADDED FOR EQUALITIES \_\_\_\_\_\_LIN. FT. DEDUCTED FOR EQUALITIES \_\_\_\_\_\_ NOT INCLUDED NOT INCLUDED NOT INCLUDED \_\_\_LIN. FT. RAILROAD CROSSINGS NO. \_\_\_\_ \_\_LIN. FT. BRIDGES \_\_\_\_ RAILROAD CROSSINGS NO. \_\_\_\_\_\_LIN. FT. RAILROAD CROSSINGS NO. \_\_\_\_\_

#### Commonwealth of Kentucky DEPARTMENT OF HIGHWAYS **COUNTY OF**

### **PULASKI**

ITEM NO. 8-926.00 PROJECT HSIP 5105 (035)
FD52 100 0070 009-010 LETTING DATE: 8-22-14 BRIAN DUNBAR 6-4-14 RECOMMENDED BY: \_\_\_\_


DATE: 7-11-2014




8-926.00


**PULASKI** 

SHEET NO.

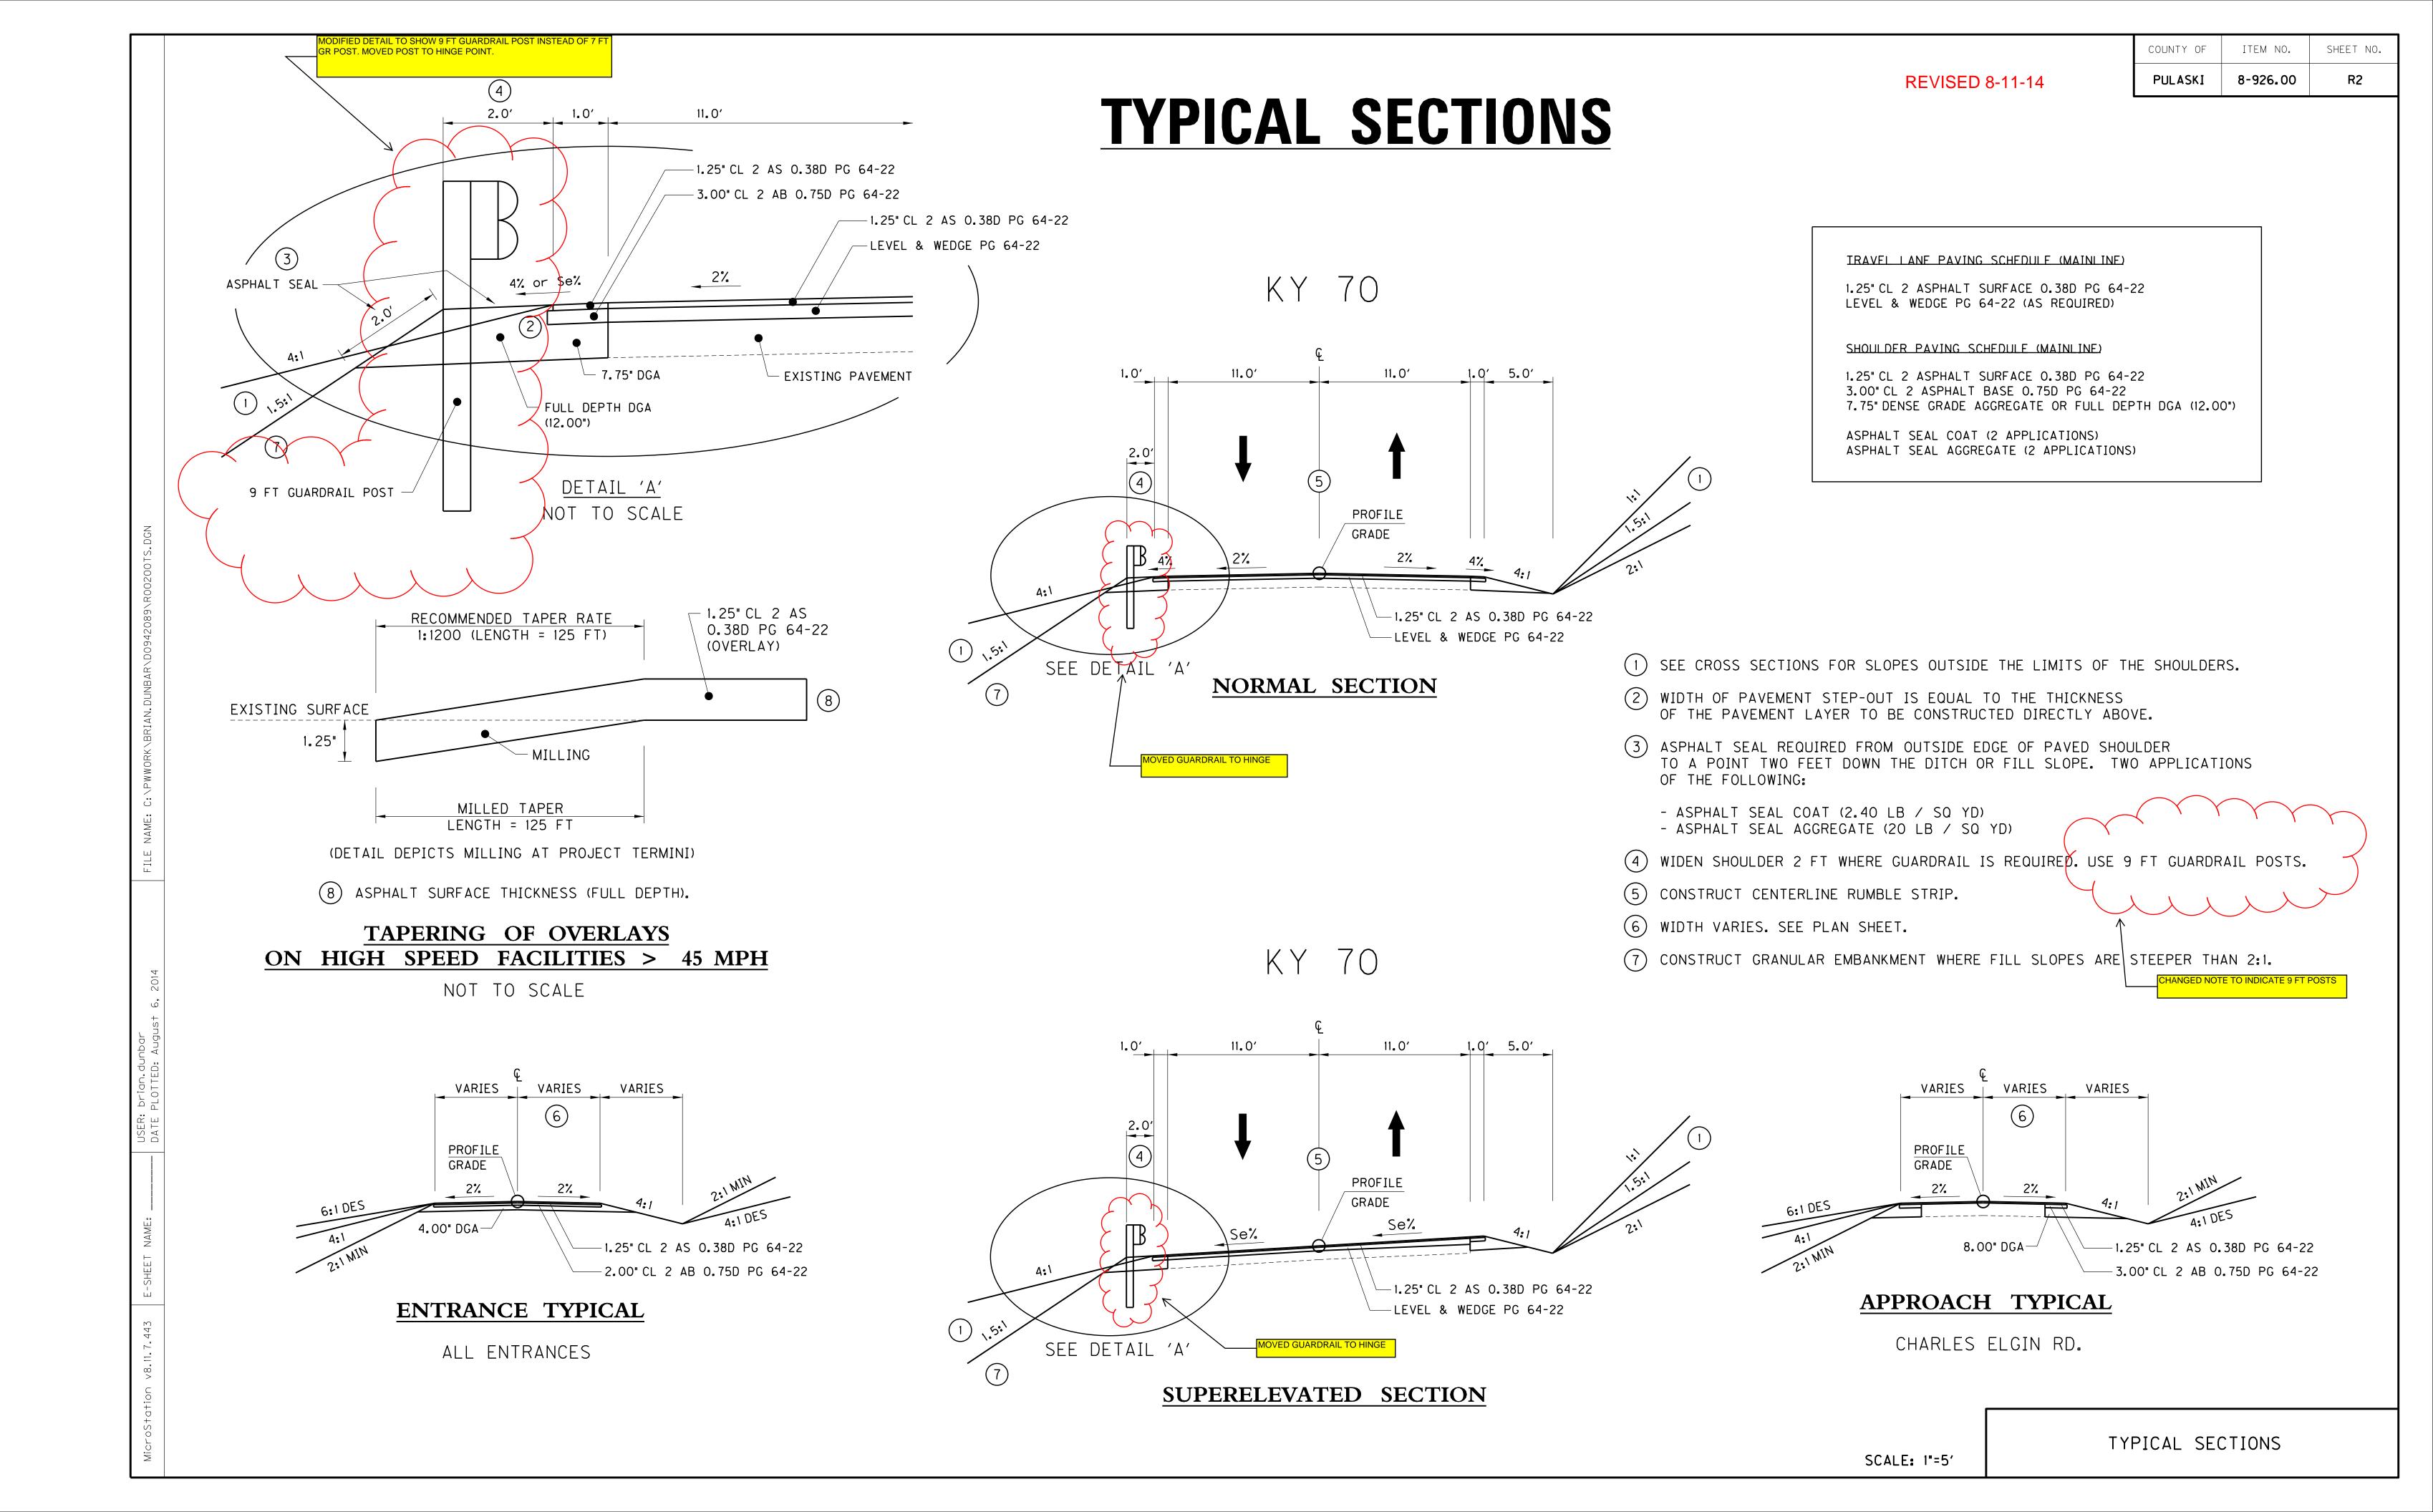

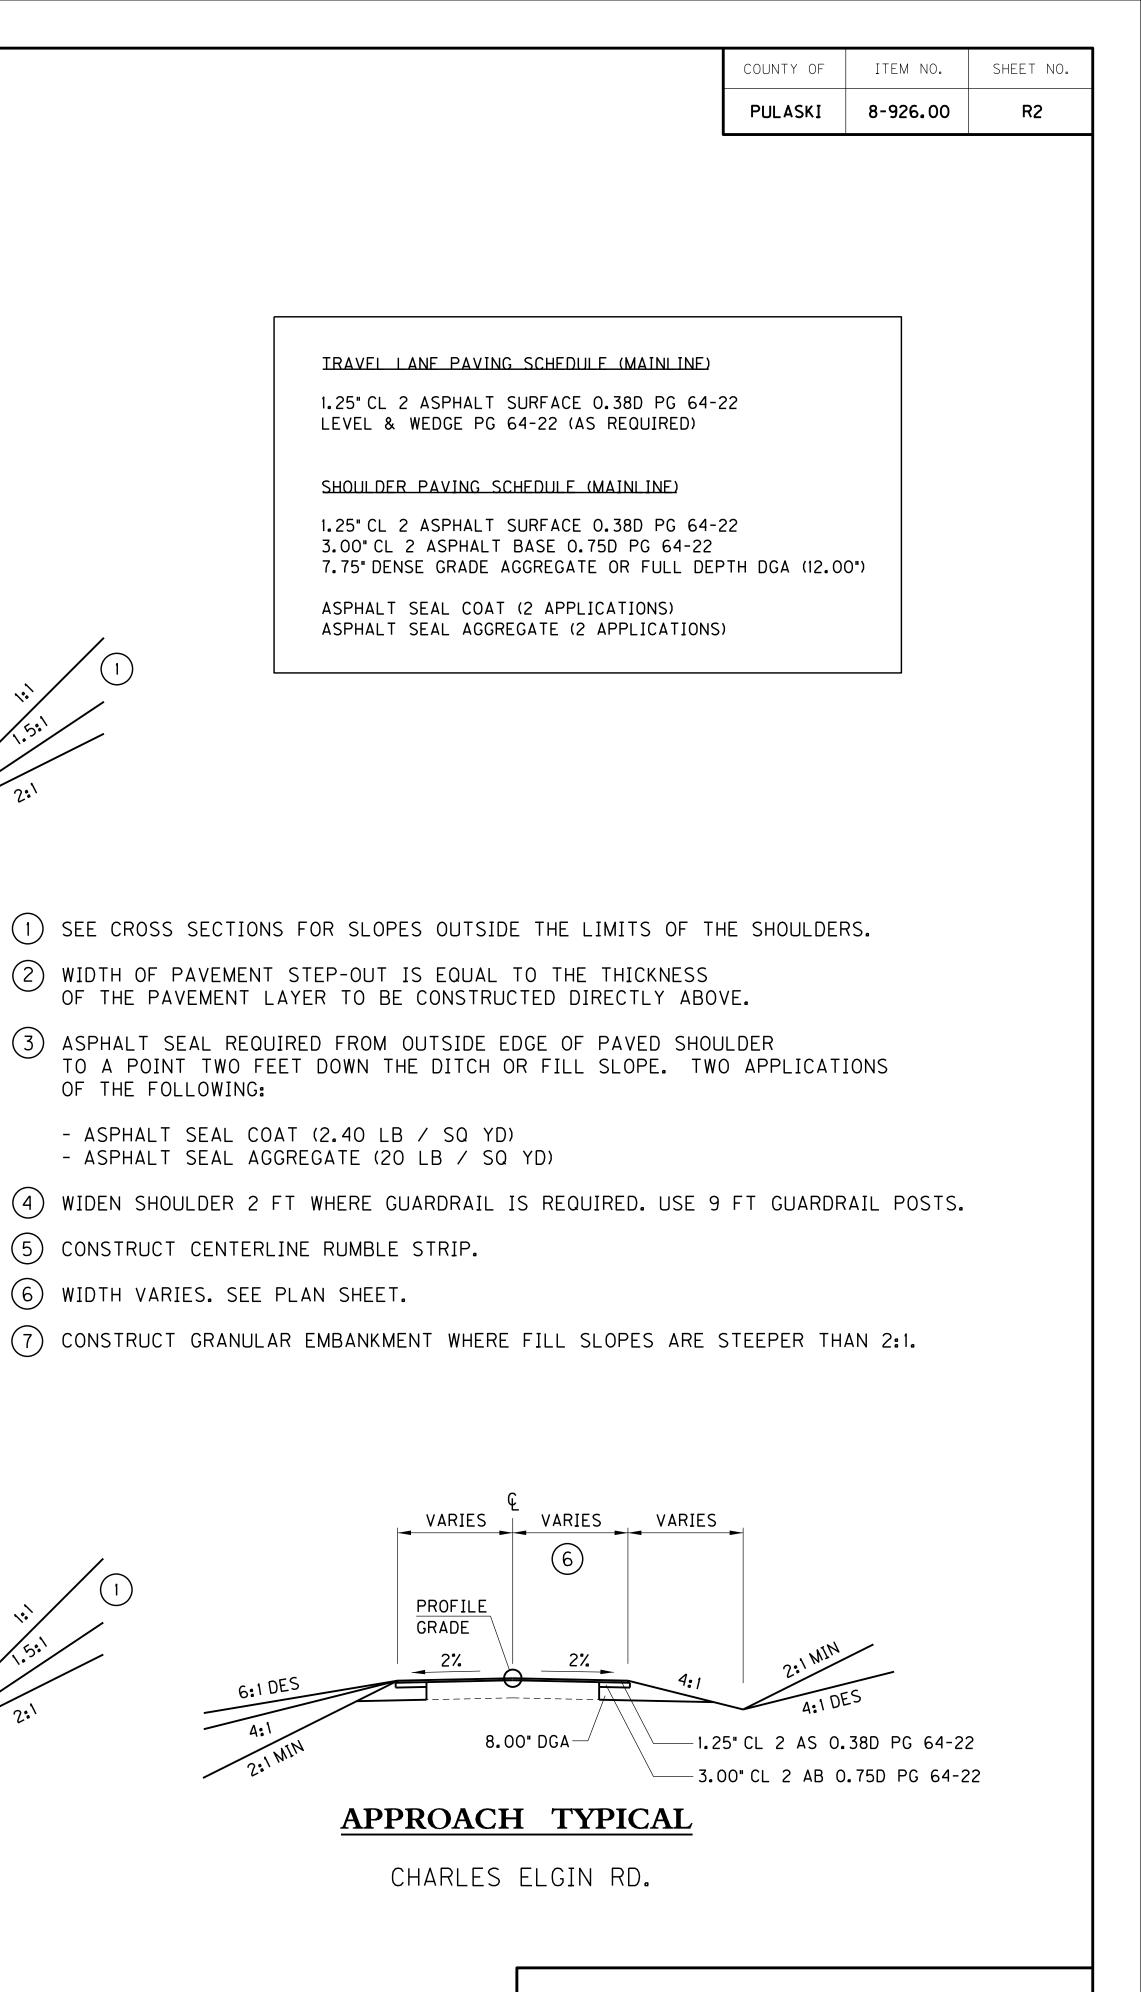

TYPICAL SECTIONS

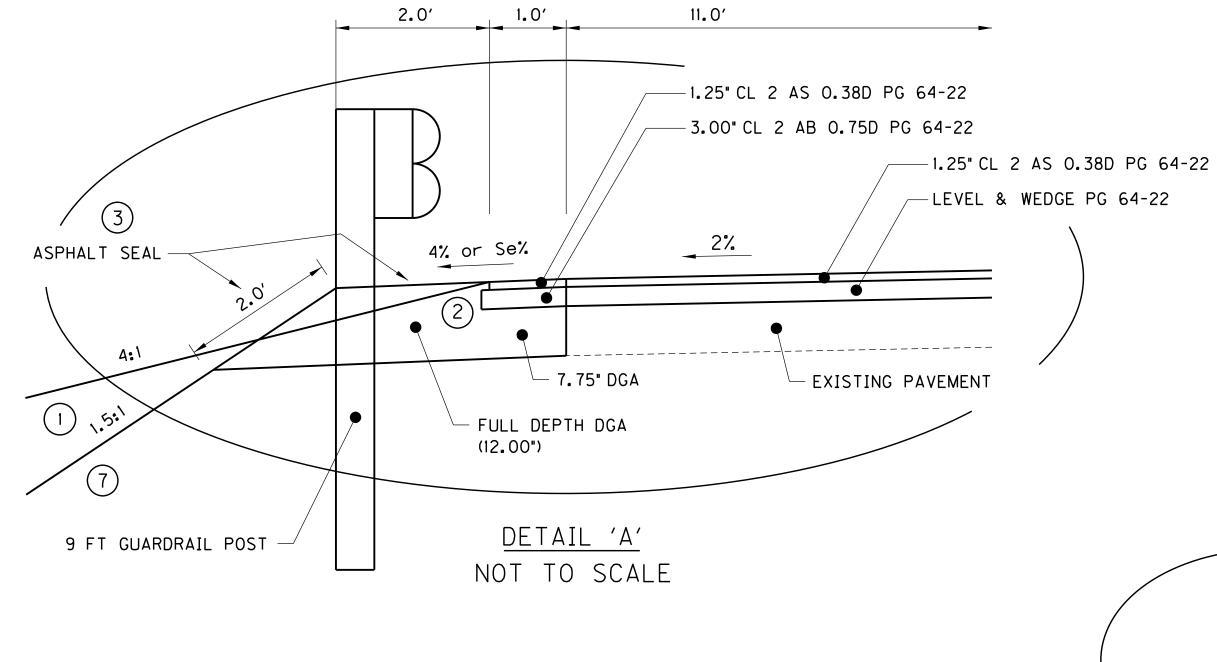

4

EDGE PG 64-22

KY 70

1.0' 11.0' 5.0'

2.0' 11.0' 5.0'

PROFILE GRADE

1.25' CL 2 AS 0.38D PG 64-22

LEVEL & WEDGE PG 64-22


LEVEL & WEDGE PG 64-22

SEE DETAIL 'A'

1 SEE CROS

NORMAL SECTION

KY 70

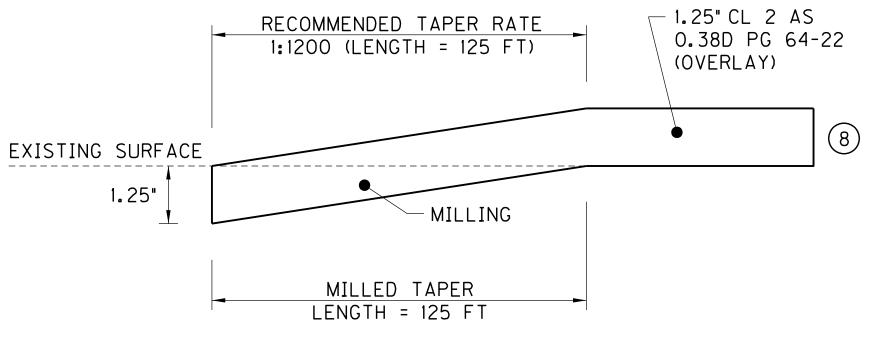


(DETAIL DEPICTS MILLING AT PROJECT TERMINI)

(8) ASPHALT SURFACE THICKNESS (FULL DEPTH).


# ON HIGH SPEED FACILITIES > 45 MPH

NOT TO SCALE

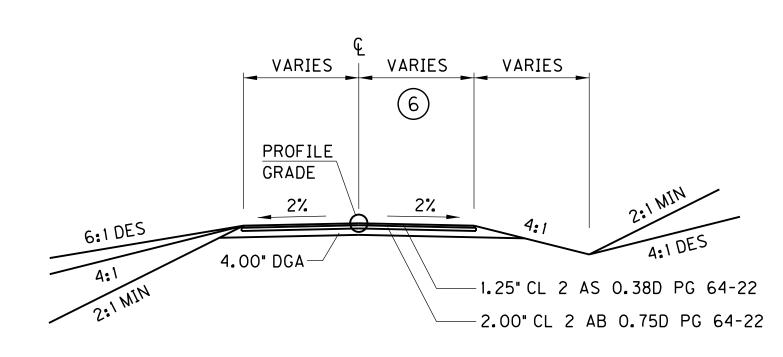

### **ENTRANCE TYPICAL**

ALL ENTRANCES

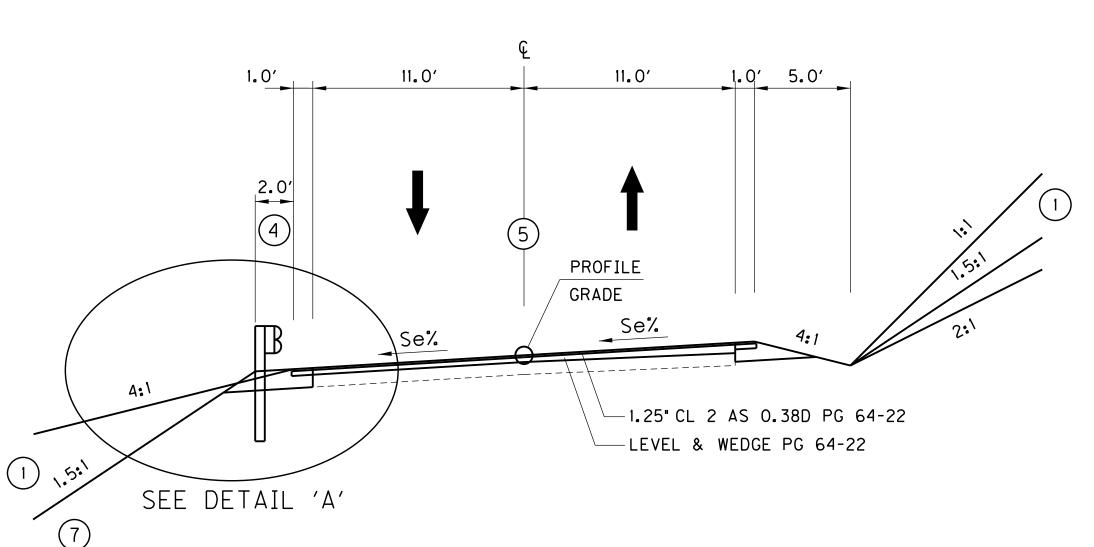

SUPERELEVATED SECTION

SCALE: 1"=5'

TYPICAL SECTIONS

ITEM CODE	ITEM	UNIT	KY 70	ENTRANCES	APPROACH		TOTAL	, E
2200	ROADWAY EXCAVATION 6 7	CU YD	2,669	30	10		2,709	F
2223	GRANULAR EMBANKMENT 6 7 9	CU YD	2,933	0	0		2,933	] (
2545	CLEARING & GRUBBING 4	LS	1	0	0		1	`
2726	STAKING	BID ITEM 21802	I GUARDRAIL STEE ND 2399 EXTRA LI	EL W-BEAM S-FA	CE (7 FT POST)	I AND ADDED BID I	TEMS 2351 GUAI	RDR/
23143ED	KPDES PERMIT & TEMPORARY EROSION CONTROL	DEAM S-FACE AI	ND 2399 EXTRA L	ENGTH GUARDI	RAIL POST			
5985	SEEDING & PROTECTION							
5963	INITIAL FERTILIZER	1011	0.02	0			0.02	
5964	20-10-10 FERTILIZER	TON	0.5	0	0		0.5	
5992	AGRICULTURAL LIMESTONE	TON	0.3	0	0		0.3	
2562	SIGNS	SQ FT	137	0	16		153	
2381	REMOVE GUARDRAIL	LF	2,113	200		······	2.113	
2351	GUARDRAIL STEEL W BEAM S - FACE (1)	LF	2,662.5	0	0		2,662.5	] 30
2399	EXTRA LENGTH GUARDRAIL POST	EA	442	0	0		442	3
2367	GUARDRAIL END TREATMENT - TYPE 1	ΕA	2	0	0		2	
2360	GUARDRAIL TERMINAL SECTION NO. 1	EA	6	0	0		6	
1987	DELINEATOR FOR GUARDRAIL - B/W	EA	55	0	0		55	
5950	EROSION CONTROL BLANKET	SQ YD	500	0	0		500	
2650	MAINTAIN & CONTROL TRAFFIC	LS	1	0	0		1	
6514	PAVEMENT STRIPING - PERM PAINT - 4 IN	LF	8,000	0	0		8,000	
6510	PAVEMENT STRIPING - TEMP PAINT - 4 IN	LF	4,000	0	0		4,000	
20458ES403	CENTERLINE RUMBLE STRIPS	LF	2,000	0	0		2,000	
2671	PORTABLE CHANGEABLE MESSAGE SIGN	EA	2	0	0		2	
2600	FABRIC GEOTEXTILE TYPE IV FOR PIPE	SQ YD	0	0	100		100	
2569	DEMOBILIZATION	LS	mmm	mhmm	mhim	·····	mm	
2704	SILT TRAP TYPE B	EA	1	0	0		1	B
	ADDED BID ITEM 40037 SILT TRAP TYPE B							-

#### NOTES

ALL ASPHALT MIXTURES SHALL BE ESTIMATED AT 110 LBS. PER SQ. YD. PER INCH OF DEPTH, UNLESS NOTED OTHERWISE.

① ESTIMATED AT 115 LBS. PER SQ. YD. PER INCH OF DEPTH.

ESTIMATED AT 110 LBS. PER SQ. YD. PER INCH OF DEPTH.

ESTIMATED AT 95 LBS. PER SQ. YD. PER INCH OF DEPTH.

- APPROXIMATELY 0.1 ACRES.
- 5 SEE SPECIAL NOTE IN PROPOSAL.

#### ROADWAY EXCAVATION

MAINLINE COMMON: 299 CU YD COM FOR EMB BENCHES: 2,370 CU YD ENTRANCE COMMON: 30 CU YD APPROACH COMMON: 10 CU YD

TOTAL ROADWAY EXC: 2,709 CU YD

#### EMBANKMENT IN PLACE (8)

MAINLINE EMB: 405 CU YD ENTRANCE EMB: 250 CU YD APPROACH EMB: 10 CU YD SOIL REFILL: 155 CU YD

TOTAL EMB IN PLACE: 820 CU YD

#### GRANULAR EMBANKMENT (9)

MAINLINE GRAN EMB: 718 CU YD ENTRANCE GRAN EMB: 0 CU YD APPROACH GRAN EMB: 0 CU YD GRANULAR REFILL: 2,215 CU YD

TOTAL GRANULAR EMB: 2,933 CU YD

### PIPE DRAINAGE SUMMARY

SHEET NO.		SKEW	DESIGN PH LEVEL	MAX COVER HEIGHT	CULVERT PIPE 18 IN	S & F BOX INLET / OUTLET 18 IN	12' × 6' RCBC		REMARKS
	ITEM CODE				462	1450	N/A		
	UNIT TO BID				LF	EA	LF		
	MAINLINE								
	STA. 18+82.27	30°07′58" RT.	М	4.5'			9		EXTEND 12' × 6' RCBC 9 LF
	APPROACH (RT. STA. 21+29.0)								
	STA. 0+22.89	07°06′50" LT.	М	2.8′	71	2			
	TOTAL PROJECT			l	71	2	9		

ITEM	KY 70	ENTRANCES	APPROACH		TOTAL PROJECT
	<u> </u>	A U A	R E	YARI	D S
1.25" CL 2 ASPHALT SURFACE 0.38D PG 64-22	5,334	436	114		5,884
2.00" CL 2 ASPHALT BASE 0.75D PG 64-22	0	442	0		442
3.00" CL 2 ASPHALT BASE 0.75D PG 64-22	491	0	226		717
4.00" DENSE GRADE AGGREGATE	0	442	0		442
7.75" DENSE GRADE AGGREGATE	491	0	0		491
8.00" DENSE GRADE AGGREGATE	0	0	226		226
DENSE GRADE AGGREGATE WEDGE (CU YD)	507	13	8		528
LEVELING & WEDGING PG 64-22 (CU YD)	416	0	0		416
ASPHALT PAVEMENT MILLING & TEXTURING (CU YD)	11	0	2		13
ASPHALT SEAL AGGREGATE (2 - APPLICATIONS)	3,620	0	0		3,620
ASPHALT SEAL COAT (2 - APPLICATIONS)	3,620	0	0		3,620

### **PAVING SUMMARY**

ITEM CODE	ITEM		UNIT	KY 70	ENTRANCES	APPROACH	TOTAL
301	CL 2 ASPHALT SURFACE 0.38D PG 64-22	2	TON	367	30	8	405
221	CL 2 ASPHALT BASE 0.75D PG 64-22	2	TON	82	49	38	169
1	DENSE GRADE AGGREGATE BASE	1	TON	1,269	129	120	1,518
190	LEVELING & WEDGING PG 64-22	2	TON	824	0	0	824
2677	ASPHALT PAVEMENT MILLING & TEXTURING	2	TON	22	0	4	26
2676	MOBILIZATION FOR MILLING & TEXTURING		LS	1	0	0	1
100	ASPHALT SEAL AGGREGATE		TON	37	0	0	37
103	ASPHALT SEAL COAT		TON	5	0	0	5

- 7 EARTHWORK QUANTITY IS AN APPROXIMATION AND FOR INFORMATION ONLY. CONTRACTOR ASSUMES RESPONSIBILITY FOR ANY DISCREPANCY THAT MAY EXIST BETWEEN ESTIMATE AND ACTUAL QUANTITY.
- (8) MATERIAL USED AS EMBANKMENT IN PLACE SHALL MEET MINIMUM CBR VALUE OF 3.
- 9 CONSTRUCT GRANULAR EMBANKMENT WHERE FILL SLOPES ARE STEEPER THAN 2:1.
- 10 USE 9 FT GUARDRAIL POSTS.

ADDED NOTE 10

SUMMARY OF QUANTITIES

ITEM CODE	ITEM	UNIT	KY 70	ENTRANCES	APPROACH	TOTAL
2200	ROADWAY EXCAVATION 6 7	CU YD	2,669	30	10	2,709
2223	GRANULAR EMBANKMENT 6 7 9	CU YD	2,933	0	0	2,933
2545	CLEARING & GRUBBING 4	LS	1	0	0	1
2726	STAKING	LS	1	0	0	1
23143ED	KPDES PERMIT & TEMPORARY EROSION CONTROL 5	LS	1	0	0	1
5985	SEEDING & PROTECTION	SQ YD	10,000	0	0	10,000
5963	INITIAL FERTILIZER	TON	0.02	0	0	0.02
5964	20-10-10 FERTILIZER	TON	0.5	0	0	0.5
5992	AGRICULTURAL LIMESTONE	TON	0.3	0	0	0.3
2562	SIGNS	SQ FT	137	0	16	153
2381	REMOVE GUARDRAIL	LF	2,113	0	0	2,113
2351	GUARDRAIL STEEL W BEAM S - FACE	LF	2,662.5	0	0	2,662.5
2399	EXTRA LENGTH GUARDRAIL POST	EA	442	0	0	442
2367	GUARDRAIL END TREATMENT - TYPE 1	EA	2	0	0	2
2360	GUARDRAIL TERMINAL SECTION NO. 1	EA	6	0	0	6
1987	DELINEATOR FOR GUARDRAIL - B/W	EA	55	0	0	55
5950	EROSION CONTROL BLANKET	SQ YD	500	0	0	500
2650	MAINTAIN & CONTROL TRAFFIC	LS	1	0	0	1
6514	PAVEMENT STRIPING - PERM PAINT - 4 IN	LF	8,000	0	0	8,000
6510	PAVEMENT STRIPING - TEMP PAINT - 4 IN	LF	4,000	0	0	4,000
20458ES403	CENTERLINE RUMBLE STRIPS	LF	2,000	0	0	2,000
2671	PORTABLE CHANGEABLE MESSAGE SIGN	EA	2	0	0	2
2600	FABRIC GEOTEXTILE TYPE IV FOR PIPE	SQ YD	0	0	100	100
2569	DEMOBILIZATION	LS	1	0	0	1
2704	SILT TRAP TYPE B	EA	1	0	0	1

**PAVING AREAS** 

COUNTY OF ITEM NO. SHEET NO.

PULASKI 8-926.00 R2A

ITEM	KY 70	C ENTRANCES	APPROACH	YARD	ν TOTAL PROJECT
1.25" CL 2 ASPHALT SURFACE 0.38D PG 64-22	5,334	436	114		5,884
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4.00" DENSE GRADE AGGREGATE	0	442	0		442
7.75" DENSE GRADE AGGREGATE	491	0	0		491
8.00" DENSE GRADE AGGREGATE	0	0	226		226
DENSE GRADE AGGREGATE WEDGE (CU YD)	507	13	8		528
LEVELING & WEDGING PG 64-22 (CU YD)	416	0	0		416
ASPHALT PAVEMENT MILLING & TEXTURING (CU YD)	11	0	2		13
ASPHALT SEAL AGGREGATE (2 - APPLICATIONS)	3,620	0	0		3,620
ASPHALT SEAL COAT (2 - APPLICATIONS)	3,620	0	0		3,620

#### NOTES

ALL ASPHALT MIXTURES SHALL BE ESTIMATED AT 110 LBS. PER SQ. YD. PER INCH OF DEPTH, UNLESS NOTED OTHERWISE.

- ① ESTIMATED AT 115 LBS. PER SQ. YD. PER INCH OF DEPTH.
- ② ESTIMATED AT 110 LBS. PER SQ. YD. PER INCH OF DEPTH.
- ③ ESTIMATED AT 95 LBS. PER SQ. YD. PER INCH OF DEPTH.
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#### 6 ROADWAY EXCAVATION

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TOTAL EMB IN PLACE: 820 CU YD

#### GRANULAR EMBANKMENT (9)

MAINLINE GRAN EMB: 718 CU YD ENTRANCE GRAN EMB: 0 CU YD APPROACH GRAN EMB: 0 CU YD GRANULAR REFILL: 2,215 CU YD

TOTAL GRANULAR EMB: 2,933 CU YD

# PIPE DRAINAGE SUMMARY

SHEET NO.		SKEW	DESIGN PH LEVEL	MAX COVER HEIGHT	CULVERT PIPE 18 IN	S & F BOX INLET / OUTLET 18 IN	12' × 6' RCBC		REMARKS
	ITEM CODE				462	1450	N/A		
	UNIT TO BID				LF	EΑ	LF		
	MAINLINE								
	STA. 18+82.27	30°07′58" RT.	М	4.5′			9		EXTEND 12' x 6' RCBC 9 LF
	APPROACH (RT. STA. 21+29.0)								
	STA. 0+22.89	07°06′50" LT.	М	2.8′	71	2			
	TOTAL PROJECT				71	2	9		

### **PAVING SUMMARY**

ITEM CODE	ITEM		UNIT	KY 70	ENTRANCES	APPROACH	TOTAL
301	CL 2 ASPHALT SURFACE 0.38D PG 64-22	2	TON	367	30	8	405
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1	DENSE GRADE AGGREGATE BASE	1	TON	1,269	129	120	1,518
190	LEVELING & WEDGING PG 64-22	2	TON	824	0	0	824
2677	ASPHALT PAVEMENT MILLING & TEXTURING	2	TON	22	0	4	26
2676	MOBILIZATION FOR MILLING & TEXTURING		LS	1	0	0	1
100	ASPHALT SEAL AGGREGATE		TON	37	0	0	37
103	ASPHALT SEAL COAT		TON	5	0	0	5

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- 8 MATERIAL USED AS EMBANKMENT IN PLACE SHALL MEET MINIMUM CBR VALUE OF 3.
- 9 CONSTRUCT GRANULAR EMBANKMENT WHERE FILL SLOPES ARE STEEPER THAN 2:1.
- 1 USE 9 FT GUARDRAIL POSTS.

SUMMARY OF QUANTITIES

PULASKI	8-926.00	R2B
COUNTY OF	ITEM NO.	SHEET NO.

#### GENERAL NOTES

160 N.G.S. (U.S.G.S.) BENCH MARKS

DO NOT DISTURB N.G.S. (U.S.G.S.) BENCH MARKS IN ANY MANNER UNLESS DIRECTED BY THE ENGINEER.

165 BEFORE YOU DIG

THE CONTRACTOR IS INSTRUCTED TO CALL 1-800-752-6007 TO REACH KY 811, THE ONE-CALL SYSTEM FOR INFORMATION ON THE LOCATION OF EXISTING UNDERGROUND UTILITIES. THE CALL IS TO BE PLACED A MINIMUM OF TWO (2) AND NO MORE THAN TEN (10) BUSINESS DAYS PRIOR TO EXCAVATION. THE CONTRACTOR SHOULD BE AWARE THAT OWNERS OF UNDERGROUND FACILITIES ARE NOT REQUIRED TO BE MEMBERS OF THE KY 811 ONE-CALL BEFORE-U-DIG (BUD) SERVICE. THE CONTRACTOR MUST COORDINATE EXCAVATION WITH THE UTILITY OWNERS, INCLUDING THOSE WHOM DO NOT SUBSCRIBE TO KY 811. IT MAY BE NECESSARY FOR THE CONTRACTOR TO CONTACT THE COUNTY COURT CLERK TO DETERMINE WHAT UTILITY COMPANIES HAVE FACILITIES IN THE AREA.

190 DEPARTMENT OF THE ARMY PERMIT AND WATER QUALITY CERTIFICATION APPROVALS

A DEPARTMENT OF THE ARMY (DA) PERMIT, WHICH MAY REQUIRE APPROVAL OF A STATE WATER QUALITY CERTIFICATION FROM THE KENTUCKY DIVISION OF WATER, REGULATES THIS PROJECT AT ONE OR MORE LOCATIONS. PERFORM ALL APPLICABLE WORK IN COMPLIANCE WITH THE CONDITIONS STATED IN THE DA PERMIT AND THE APPROVED WATER QUALITY CERTIFICATION. POST A COPY OF THE DA PERMIT AND THE WATER QUALITY CERTIFICATION IN A CONSPICUOUS PLACE AT THE PROJECT SITE. IF A DA PERMIT OR WATER QUALITY CERTIFICATION APPROVAL IS PENDING, DO NOT WORK IN OR DISTURB THE DESIGNATED AREA(S) UNTIL OBTAINING THE APPROPRIATE APPROVAL(S). REFER TO NOTICE(S) CONTAINED IN THE CONTRACT BID PROPOSAL FOR DESIGNATED AREA(S) WHERE WORK IS PROHIBITED BY THE ABSENCE OF APPROVAL.

448 COMPACTION OF ASPHALT MIXTURES

WILL ACCEPT THE COMPACTION OF ASPHALT MIXTURES FURNISHED ON THIS PROJECT BY OPTION B ACCORDING TO SUBSECTIONS 402.03.02 AND 403.03.10 OF THE STANDARD SPECIFICIATIONS.

650 STANDARD DRAWINGS

STANDARD DRAWINGS ARE NOT ATTACHED TO THESE PLANS. A STANDARD DRAWING BOOK AND THE HEADWALL SUPPLEMENTAL BOOK MAY BE OBTAINED FROM THE POLICY SUPPORT BRANCH OF THE DEPARTMENT OF ADMINISTRATIVE SERVICES IN FRANKFORT, KY. AT (502) 564-3670

#### SPECIAL NOTES

- \* SEE SPECIAL NOTE IN PROPOSAL RELATING TO THE BID ITEM 'KPDES PERMIT & TEMPORARY EROSION CONTROL'.
- \* SEE SPECIAL NOTE IN PROPOSAL RELATING TO THE BID ITEM 'PORTABLE CHANGEABLE MESSAGE SIGN'.
- \* ANY EXISTING GUARDRAIL TO BE REMOVED, MAY BE DELIVERED TO THE PULASKI COUNTY MAINTENANCE LOT.
- \* KYTC TO OBTAIN CONSENT / RELEASE FROM PROPERTY OWNER TO PERFORM WORK IN AREAS WHERE DISTURBANCE FALLS OUTSIDE OF EXISTING R/W (IE. ENTRANCE TIE DOWNS & CONSTRUCTION OF FILL SLOPE LT. STA. 21+00 TO 24+00).
- \* A TEMPORARY SILT TRAP TYPE B WILL BE INSTALLED WITHIN THE UNNAMED TRIBUTARY OF BUCK CREEK (OUTSTANDING STATE RESOURCE WATER) AT THE DOWNSTREAM END OF THE CULVRT EXTENSION AREA LOCATED AT STATION 18+82.27. THIS MEASURE WILL BE USED TO RETAIN SEDIMENT GENERATED AS A RESULT OF THE CULVERT EXTENSION AND WILL MINIMIZE THE DOWNSTREAM TRANSPORT OF SEDIMENT. FOLLOWING COMPLETION OF CONSTRUCTION, THE SILT TRAP WILL BE REMOVED AND THE AREA WILL BE RETURNED TO PRE-CONSTRUCTION CONTOURS.

ADDED SPECIAL NOTE REGARDING SILT TRAP TYPE B

COUNTY OF	ITEM NO.	SHEET NO.
PULASKI	8-926.00	R2B

#### GENERAL NOTES

160 N.G.S. (U.S.G.S.) BENCH MARKS

DO NOT DISTURB N.G.S. (U.S.G.S.) BENCH MARKS IN ANY MANNER UNLESS DIRECTED BY THE ENGINEER.

165 BEFORE YOU DIG

THE CONTRACTOR IS INSTRUCTED TO CALL 1-800-752-6007 TO REACH KY 811, THE ONE-CALL SYSTEM FOR INFORMATION ON THE LOCATION OF EXISTING UNDERGROUND UTILITIES. THE CALL IS TO BE PLACED A MINIMUM OF TWO (2) AND NO MORE THAN TEN (10) BUSINESS DAYS PRIOR TO EXCAVATION. THE CONTRACTOR SHOULD BE AWARE THAT OWNERS OF UNDERGROUND FACILITIES ARE NOT REQUIRED TO BE MEMBERS OF THE KY 811 ONE-CALL BEFORE-U-DIG (BUD) SERVICE. THE CONTRACTOR MUST COORDINATE EXCAVATION WITH THE UTILITY OWNERS, INCLUDING THOSE WHOM DO NOT SUBSCRIBE TO KY 811. IT MAY BE NECESSARY FOR THE CONTRACTOR TO CONTACT THE COUNTY COURT CLERK TO DETERMINE WHAT UTILITY COMPANIES HAVE FACILITIES IN THE AREA.

190 DEPARTMENT OF THE ARMY PERMIT AND WATER QUALITY CERTIFICATION APPROVALS

A DEPARTMENT OF THE ARMY (DA) PERMIT, WHICH MAY REQUIRE APPROVAL OF A STATE WATER QUALITY CERTIFICATION FROM THE KENTUCKY DIVISION OF WATER, REGULATES THIS PROJECT AT ONE OR MORE LOCATIONS. PERFORM ALL APPLICABLE WORK IN COMPLIANCE WITH THE CONDITIONS STATED IN THE DA PERMIT AND THE APPROVED WATER QUALITY CERTIFICATION. POST A COPY OF THE DA PERMIT AND THE WATER QUALITY CERTIFICATION IN A CONSPICUOUS PLACE AT THE PROJECT SITE. IF A DA PERMIT OR WATER QUALITY CERTIFICATION APPROVAL IS PENDING, DO NOT WORK IN OR DISTURB THE DESIGNATED AREA(S) UNTIL OBTAINING THE APPROPRIATE APPROVAL(S). REFER TO NOTICE(S) CONTAINED IN THE CONTRACT BID PROPOSAL FOR DESIGNATED AREA(S) WHERE WORK IS PROHIBITED BY THE ABSENCE OF APPROVAL.

448 COMPACTION OF ASPHALT MIXTURES


WILL ACCEPT THE COMPACTION OF ASPHALT MIXTURES FURNISHED ON THIS PROJECT BY OPTION B ACCORDING TO SUBSECTIONS 402.03.02 AND 403.03.10 OF THE STANDARD SPECIFICIATIONS.


650 STANDARD DRAWINGS


STANDARD DRAWINGS ARE NOT ATTACHED TO THESE PLANS. A STANDARD DRAWING BOOK AND THE HEADWALL SUPPLEMENTAL BOOK MAY BE OBTAINED FROM THE POLICY SUPPORT BRANCH OF THE DEPARTMENT OF ADMINISTRATIVE SERVICES IN FRANKFORT, KY. AT (502) 564-3670


#### SPECIAL NOTES


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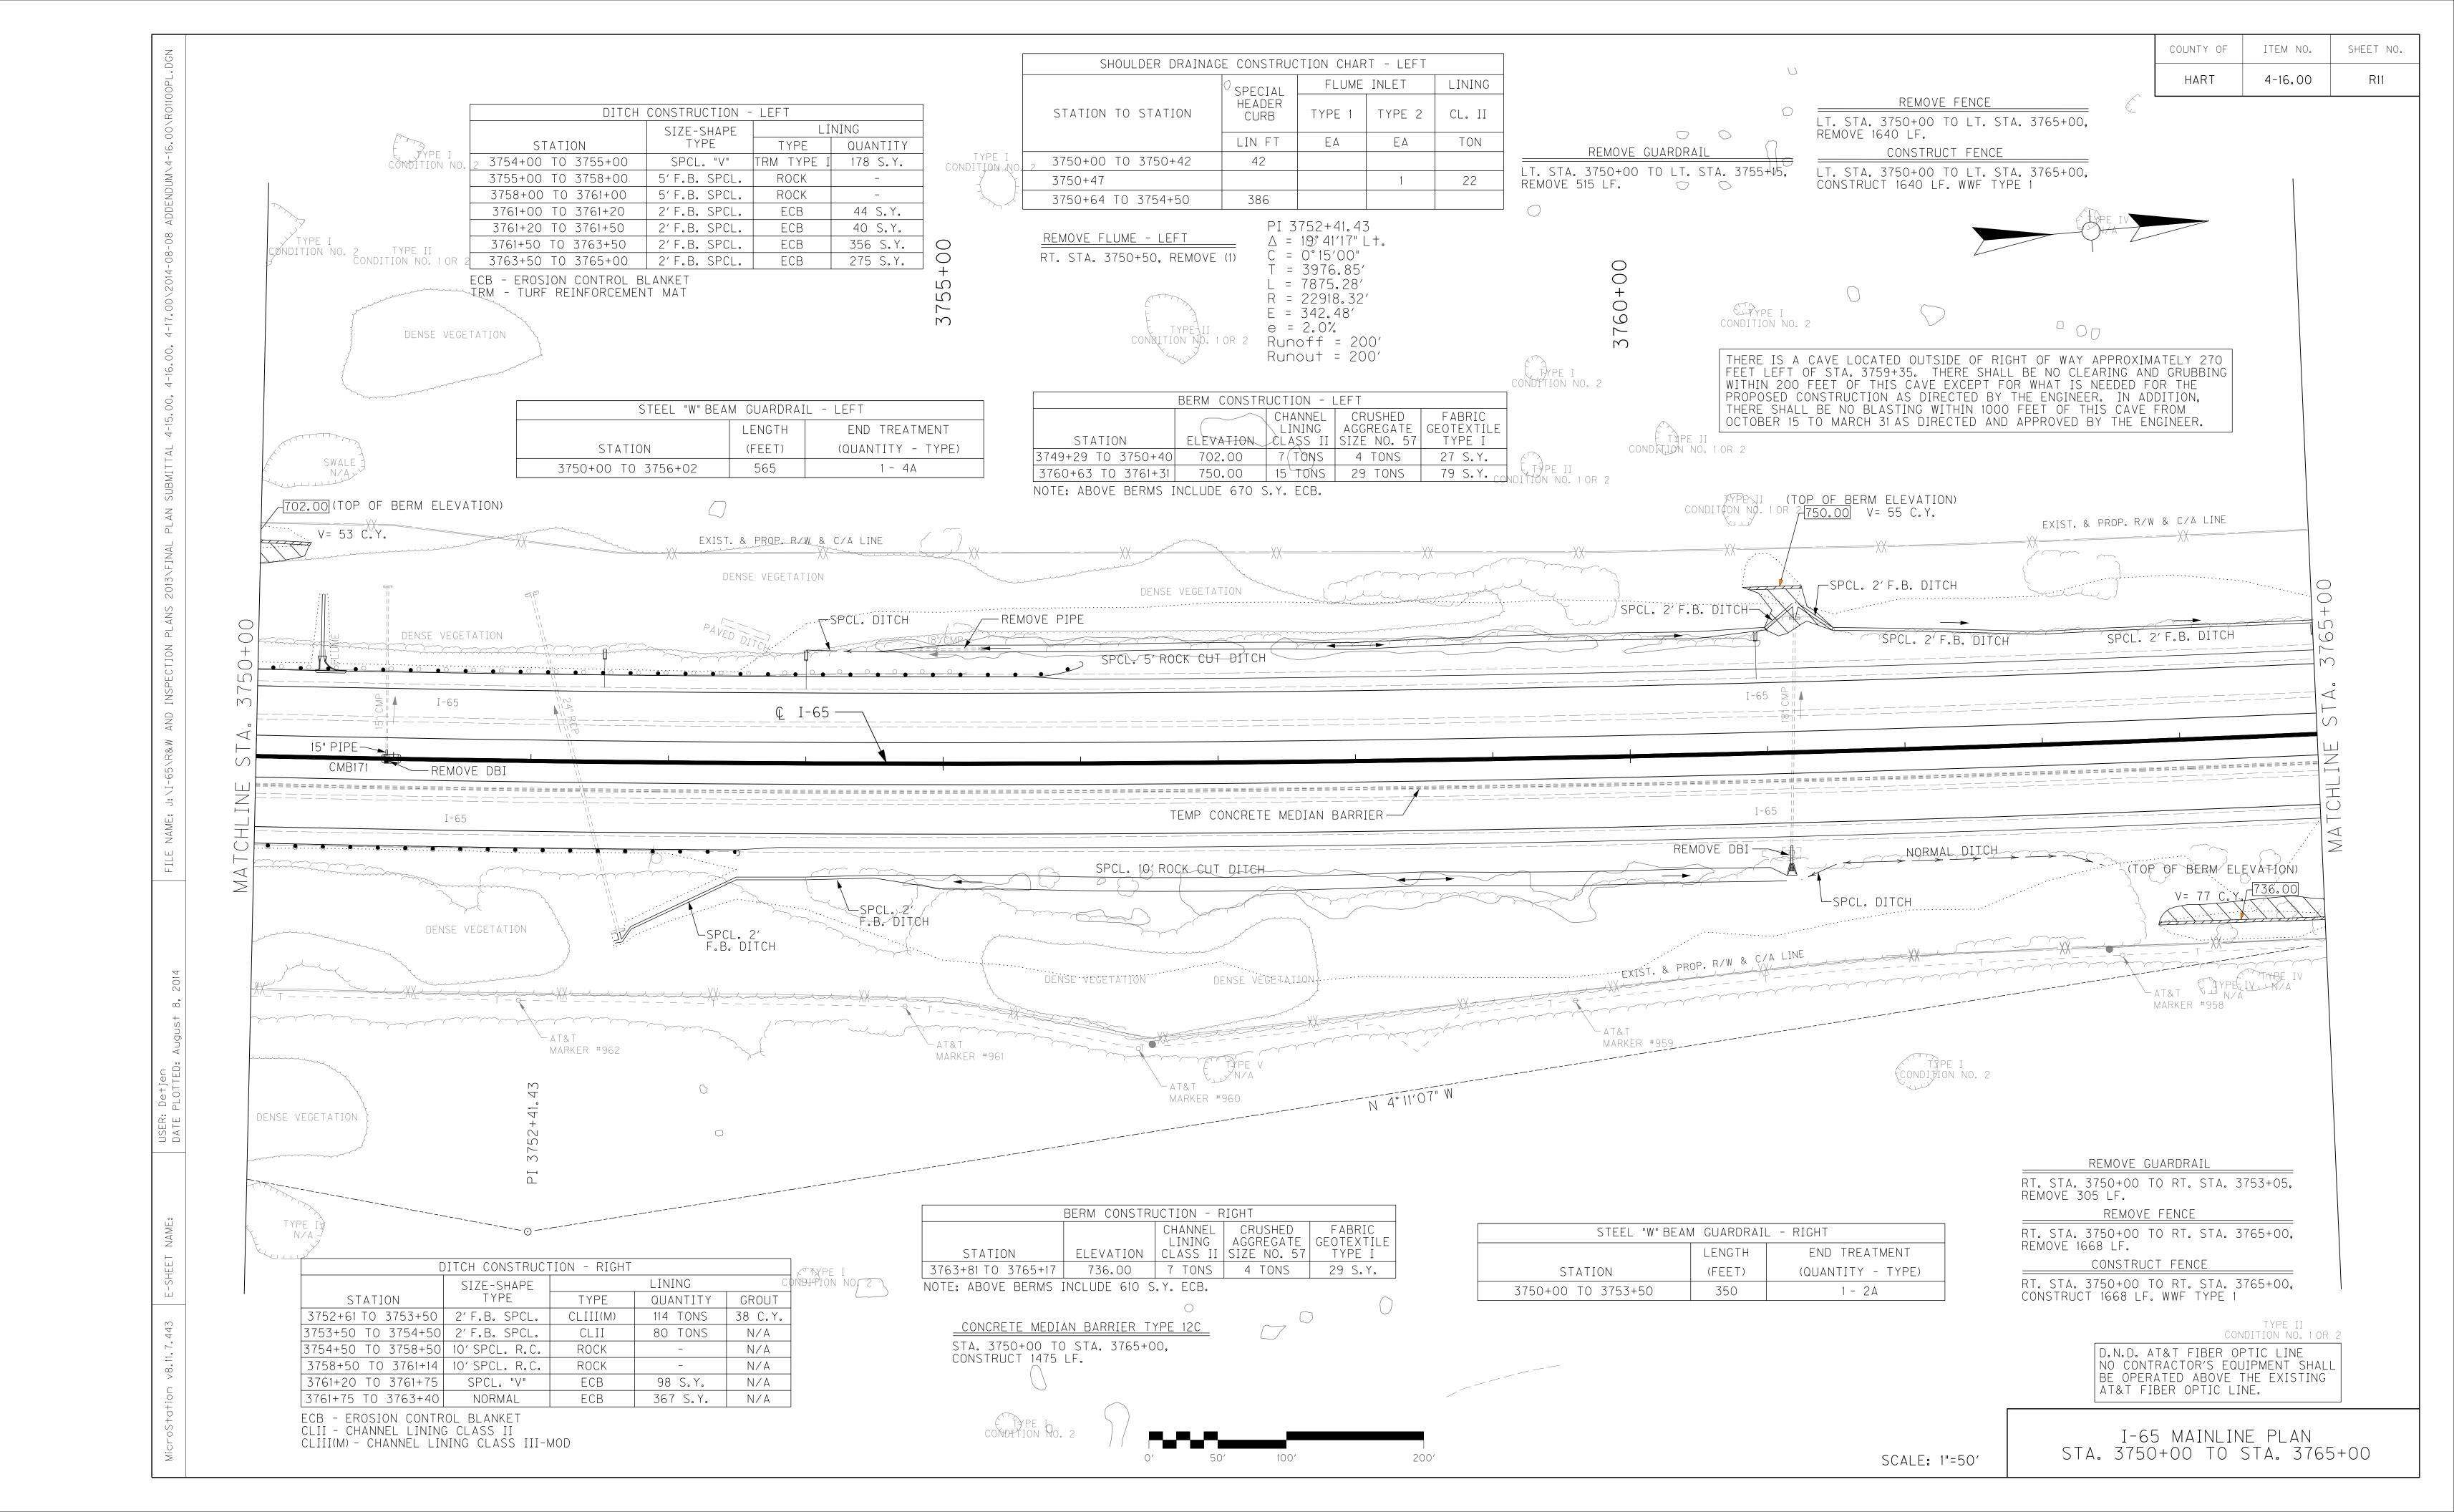


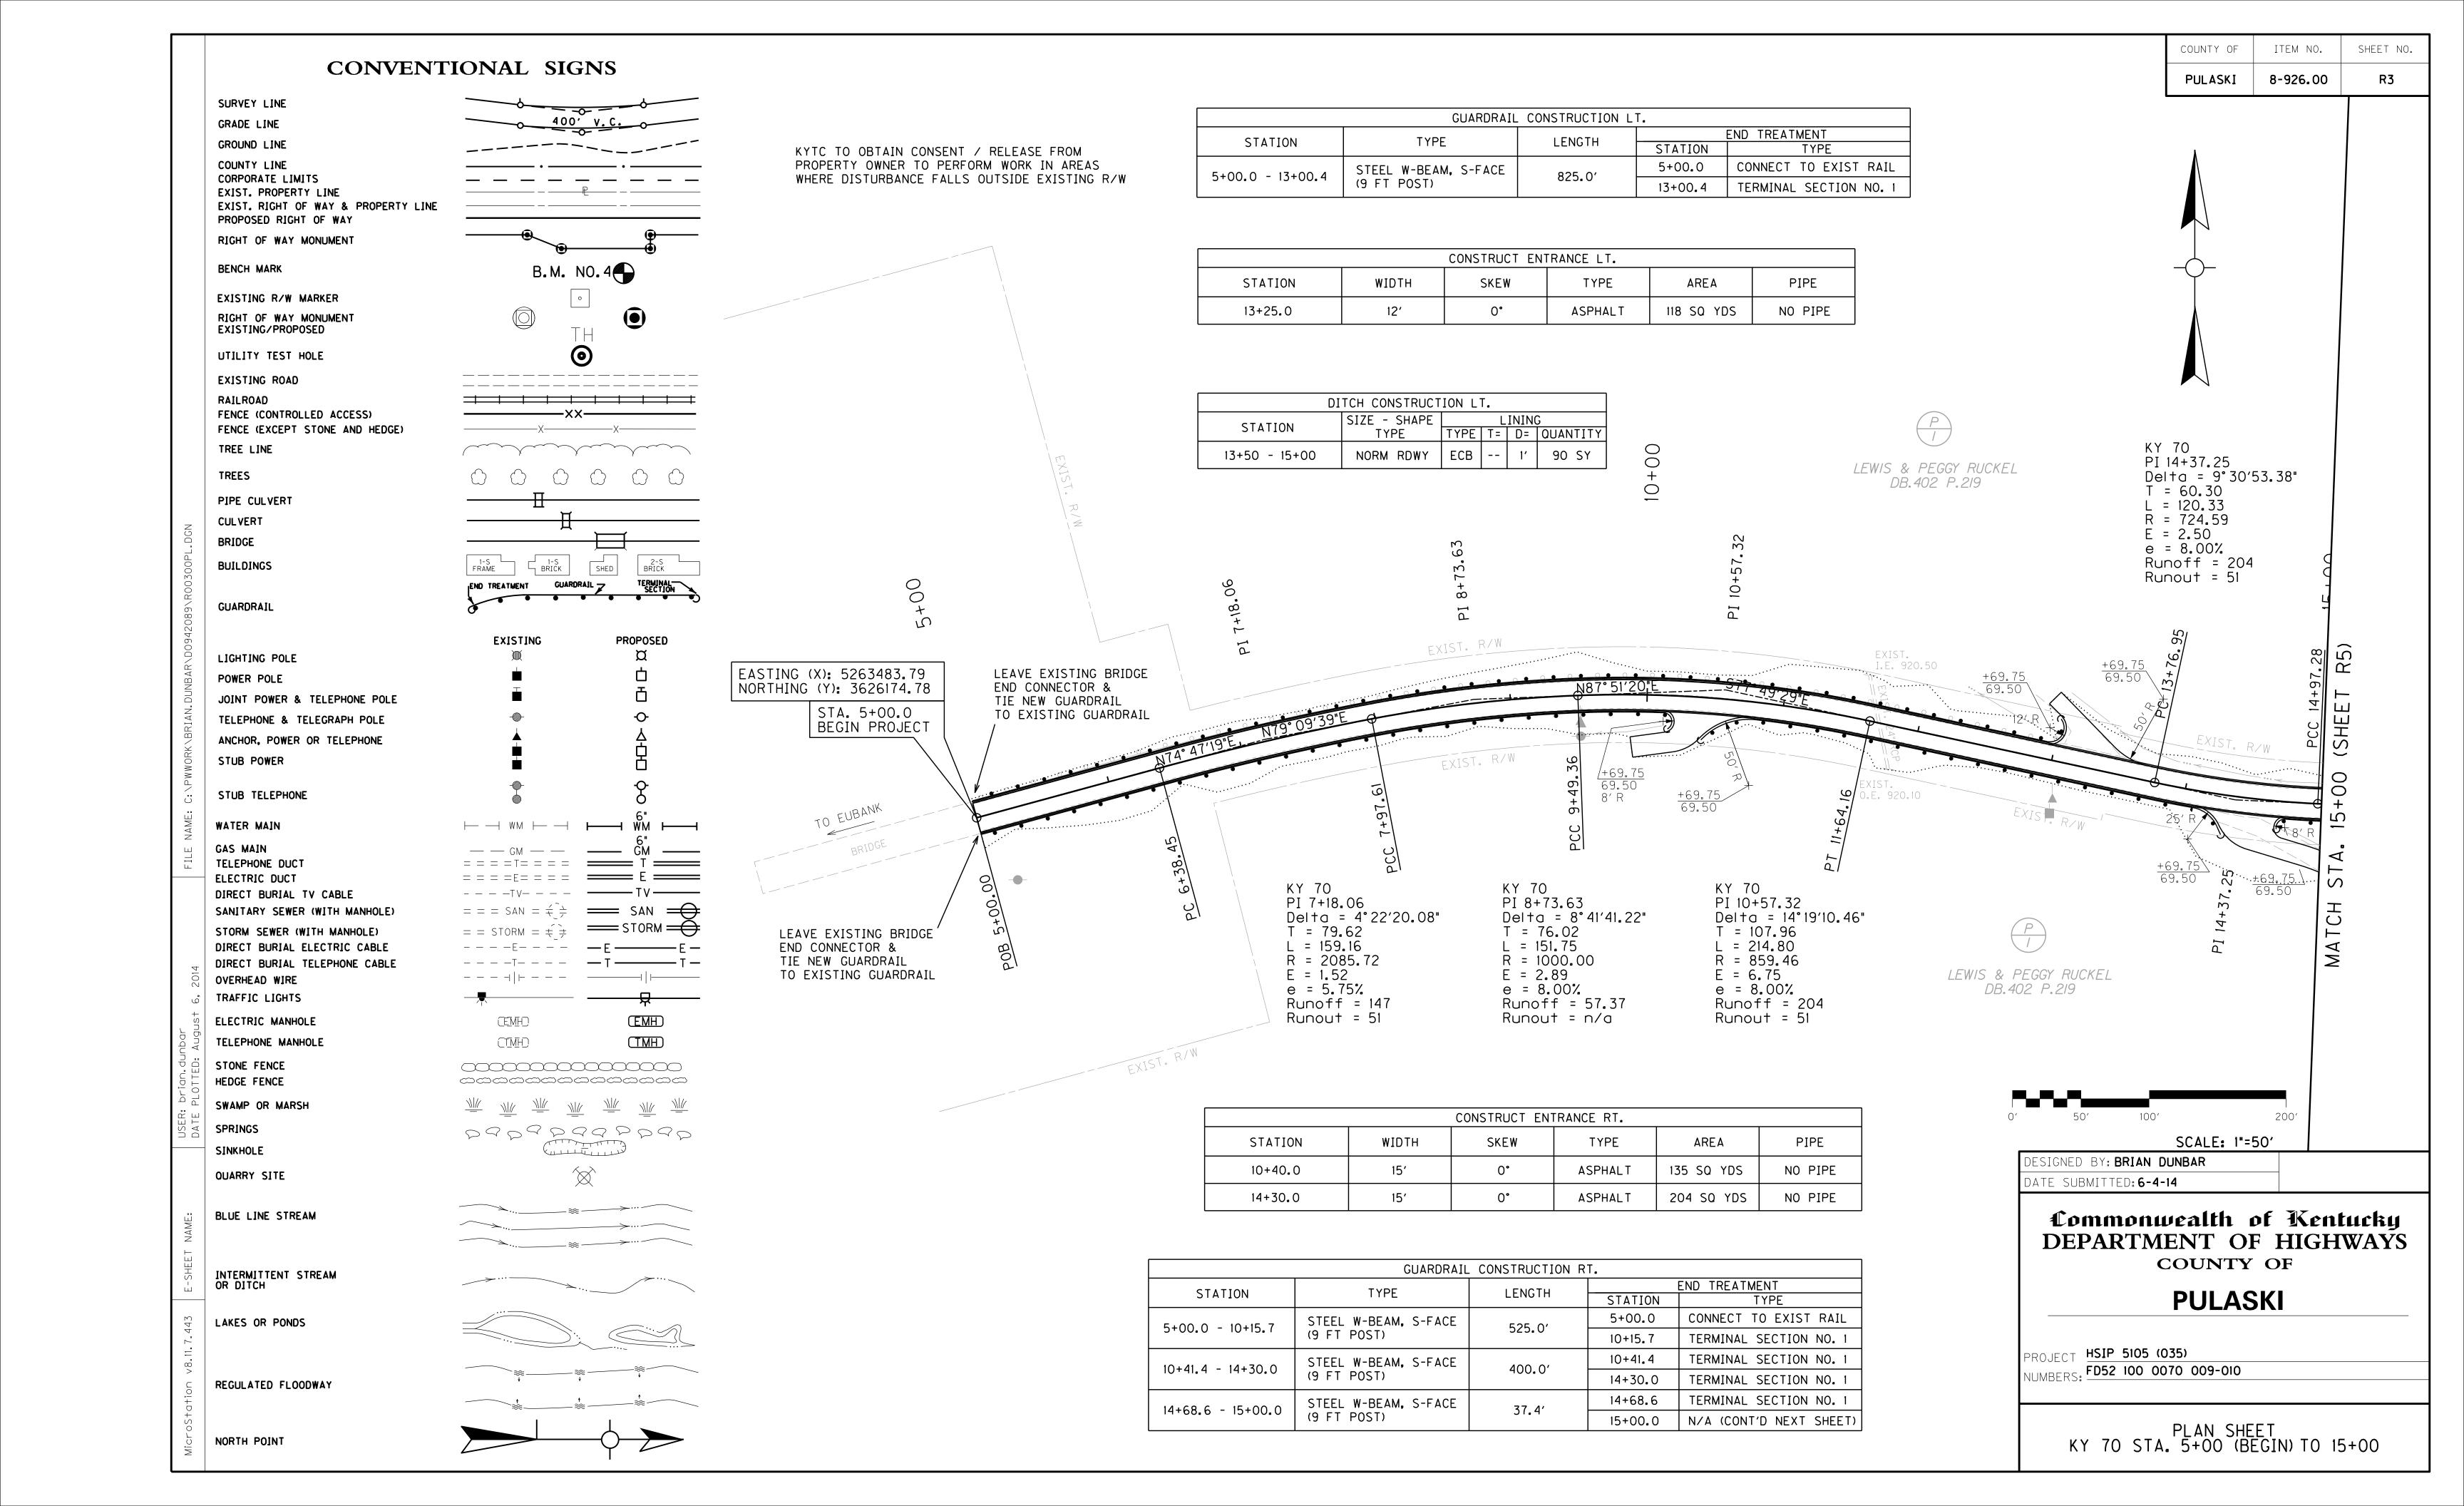

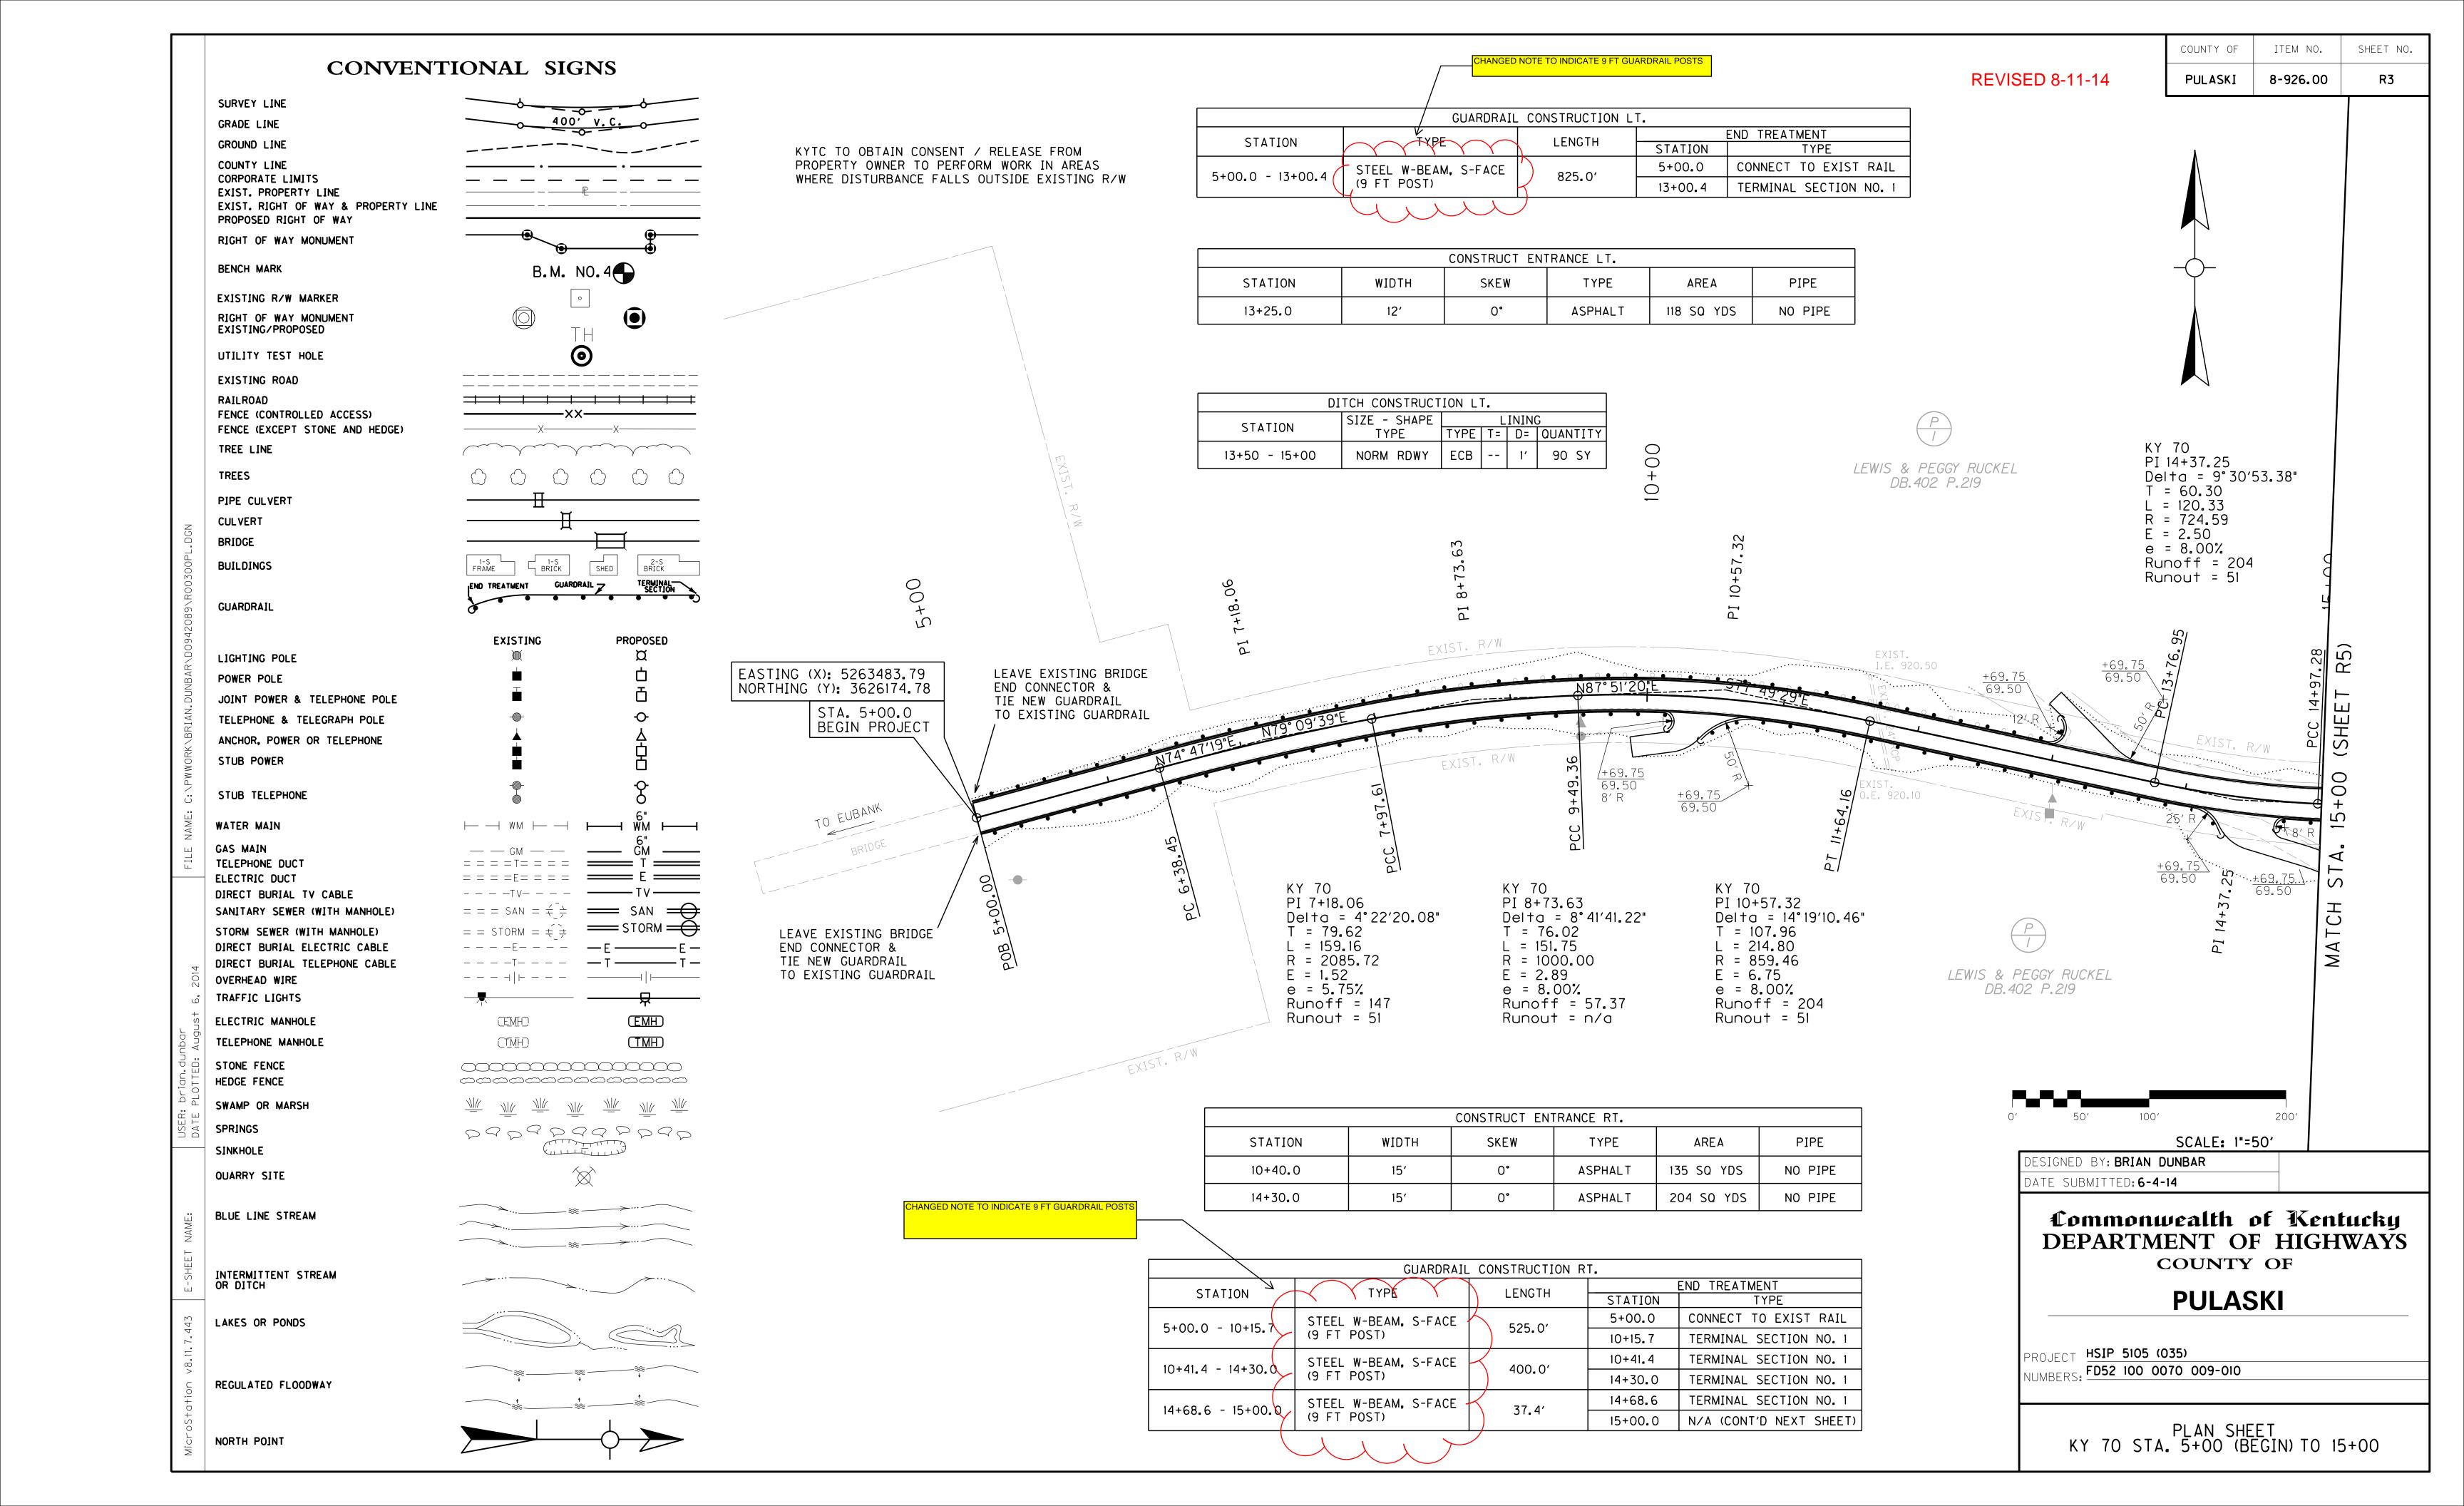


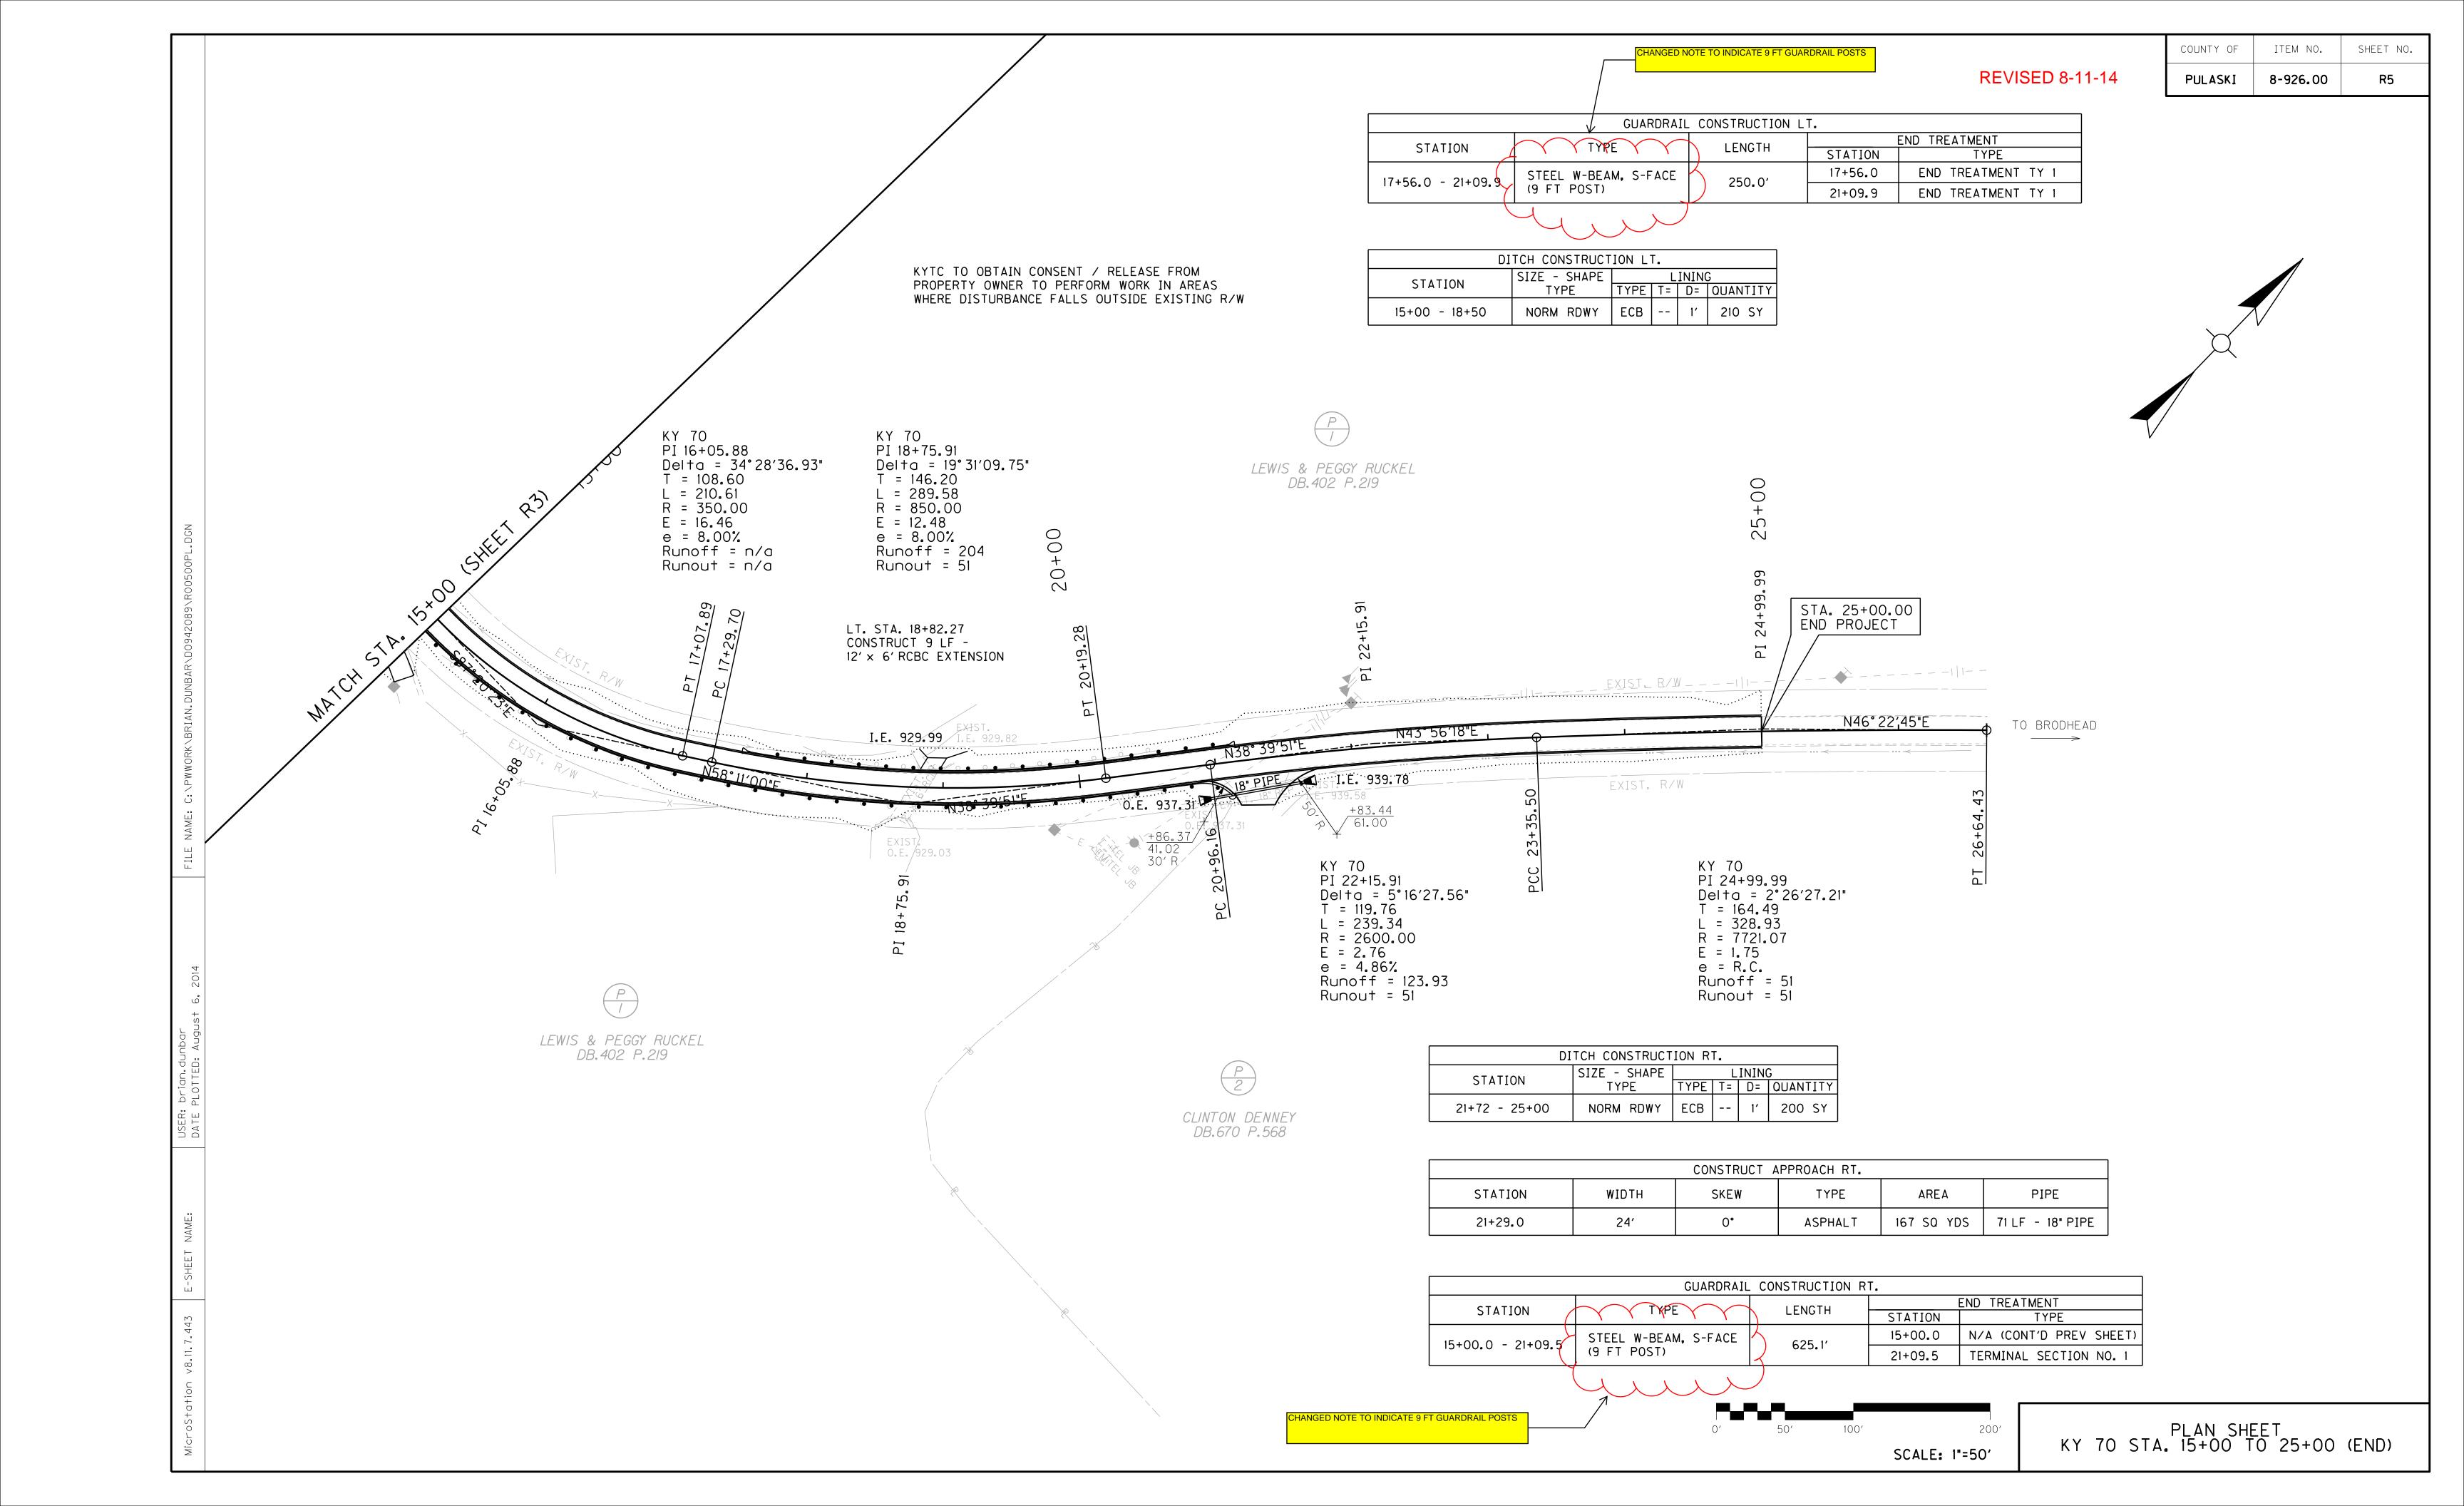

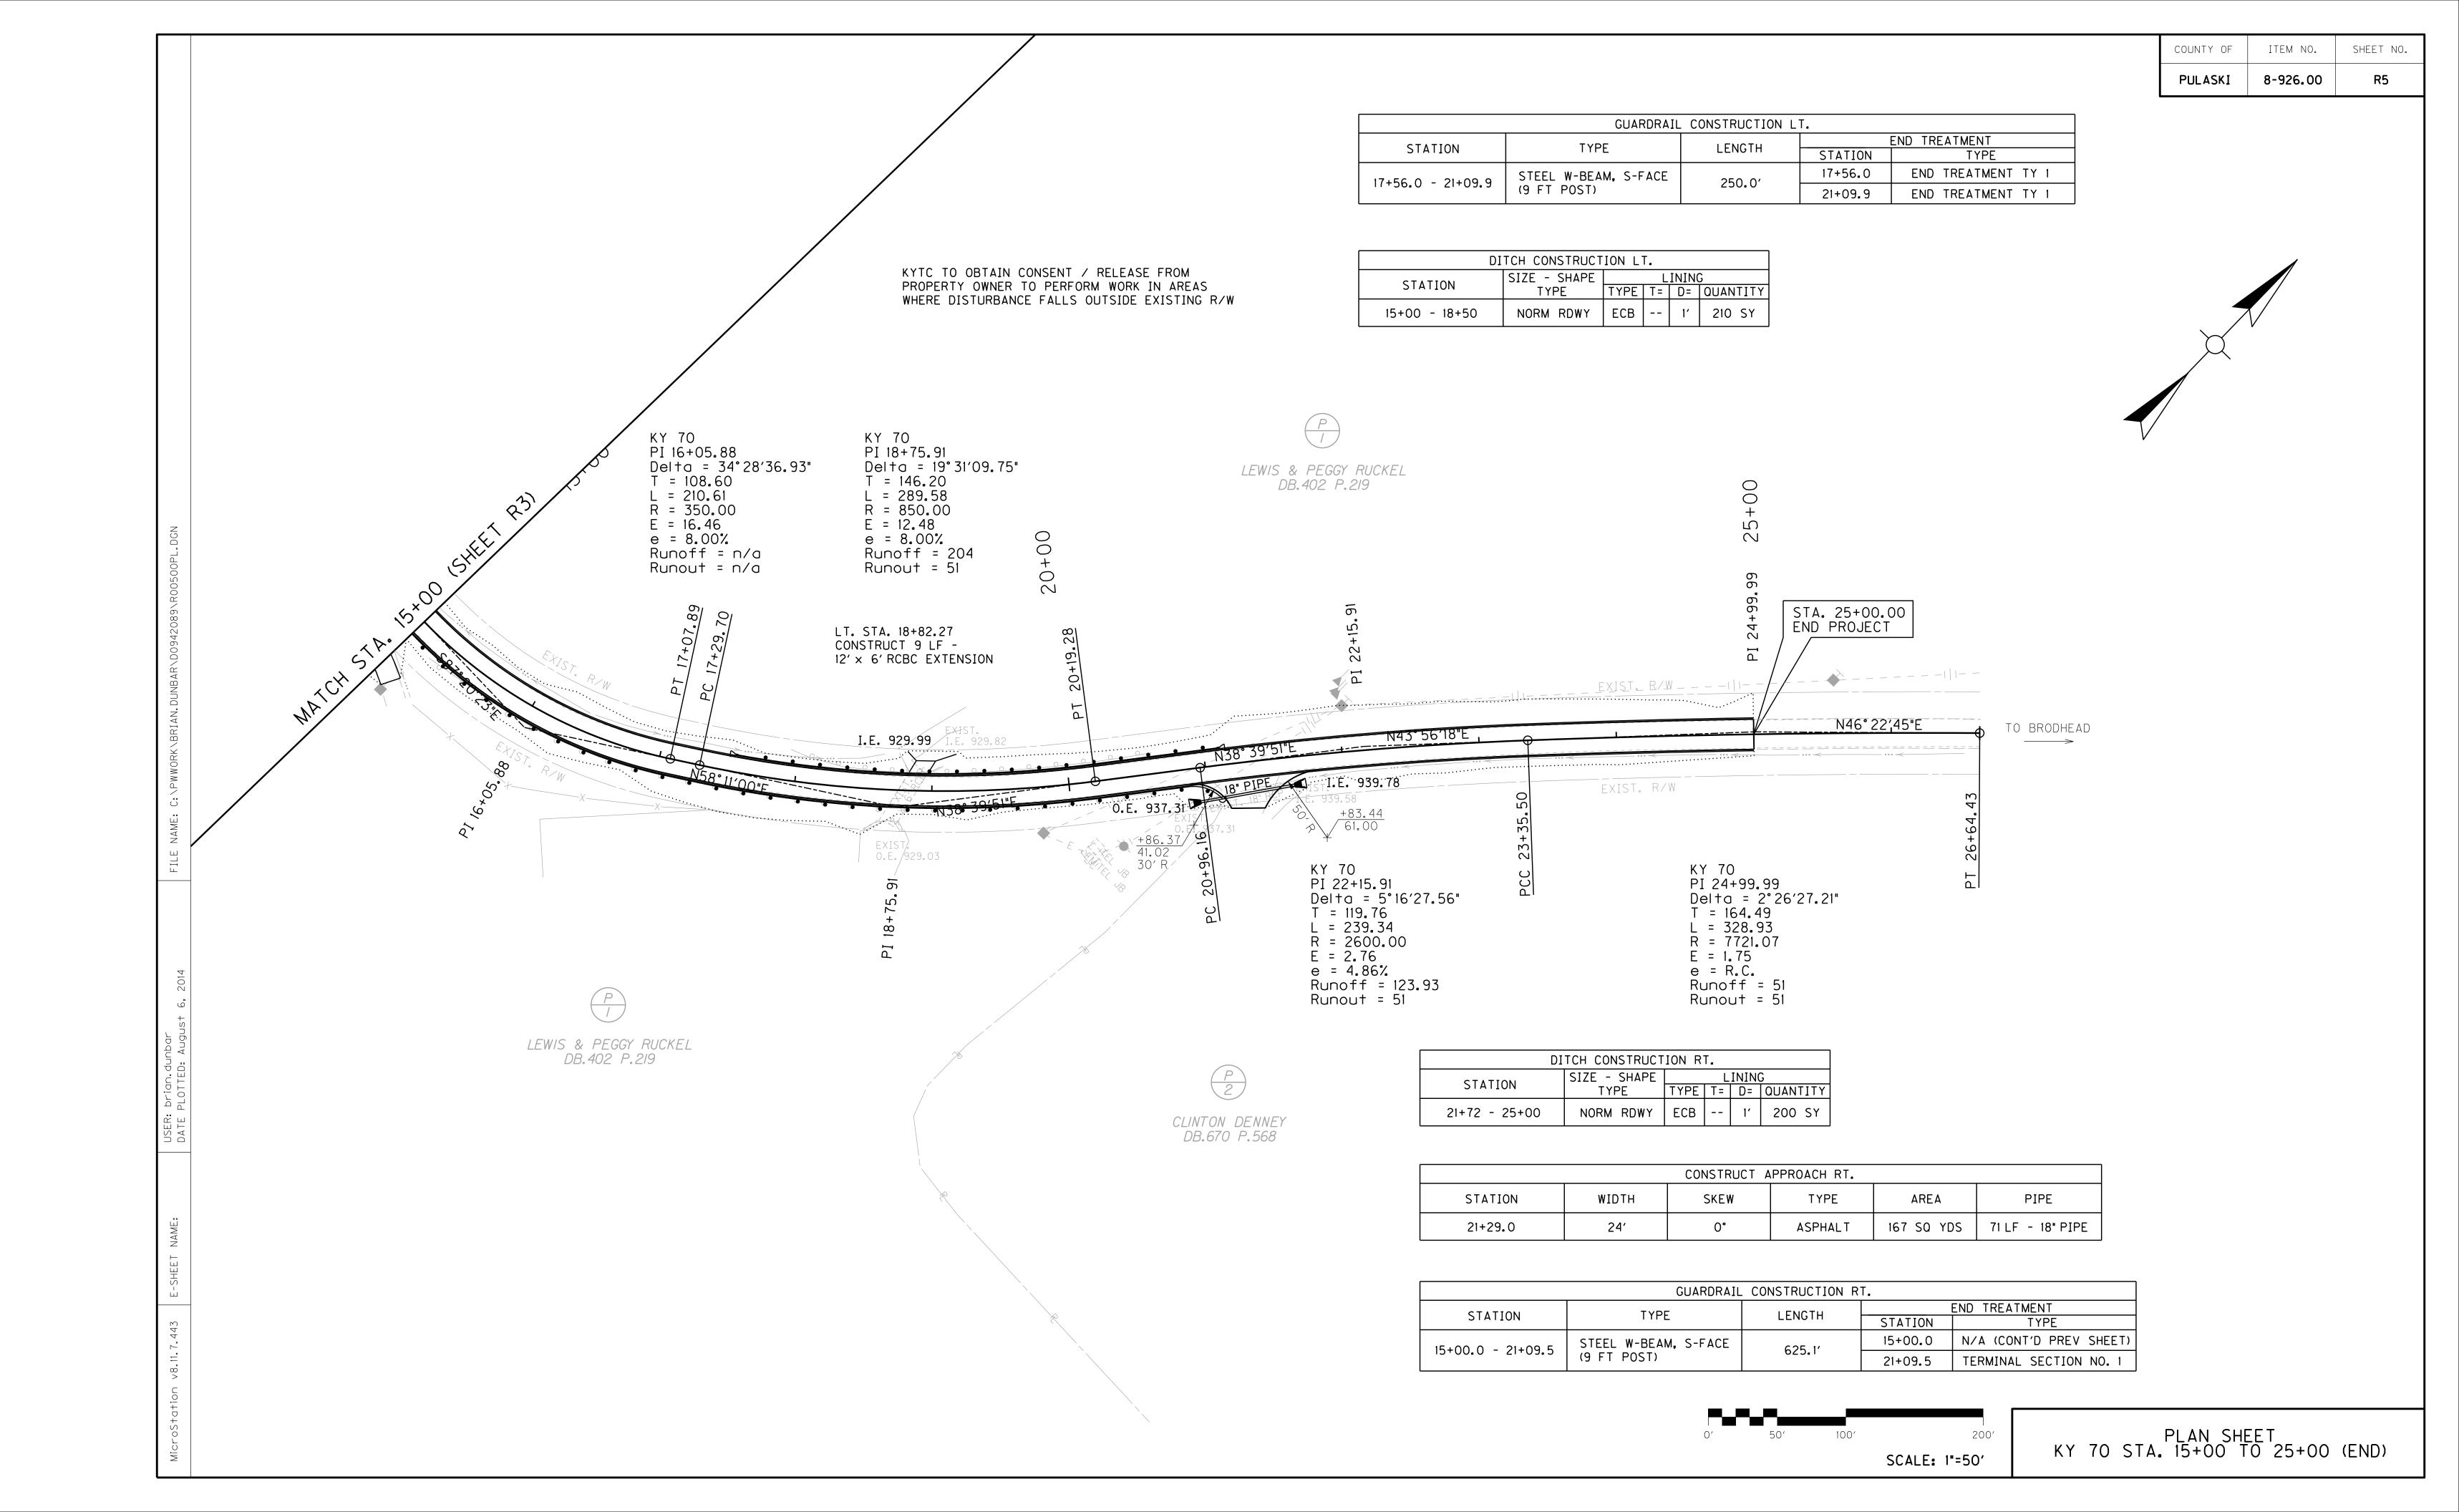

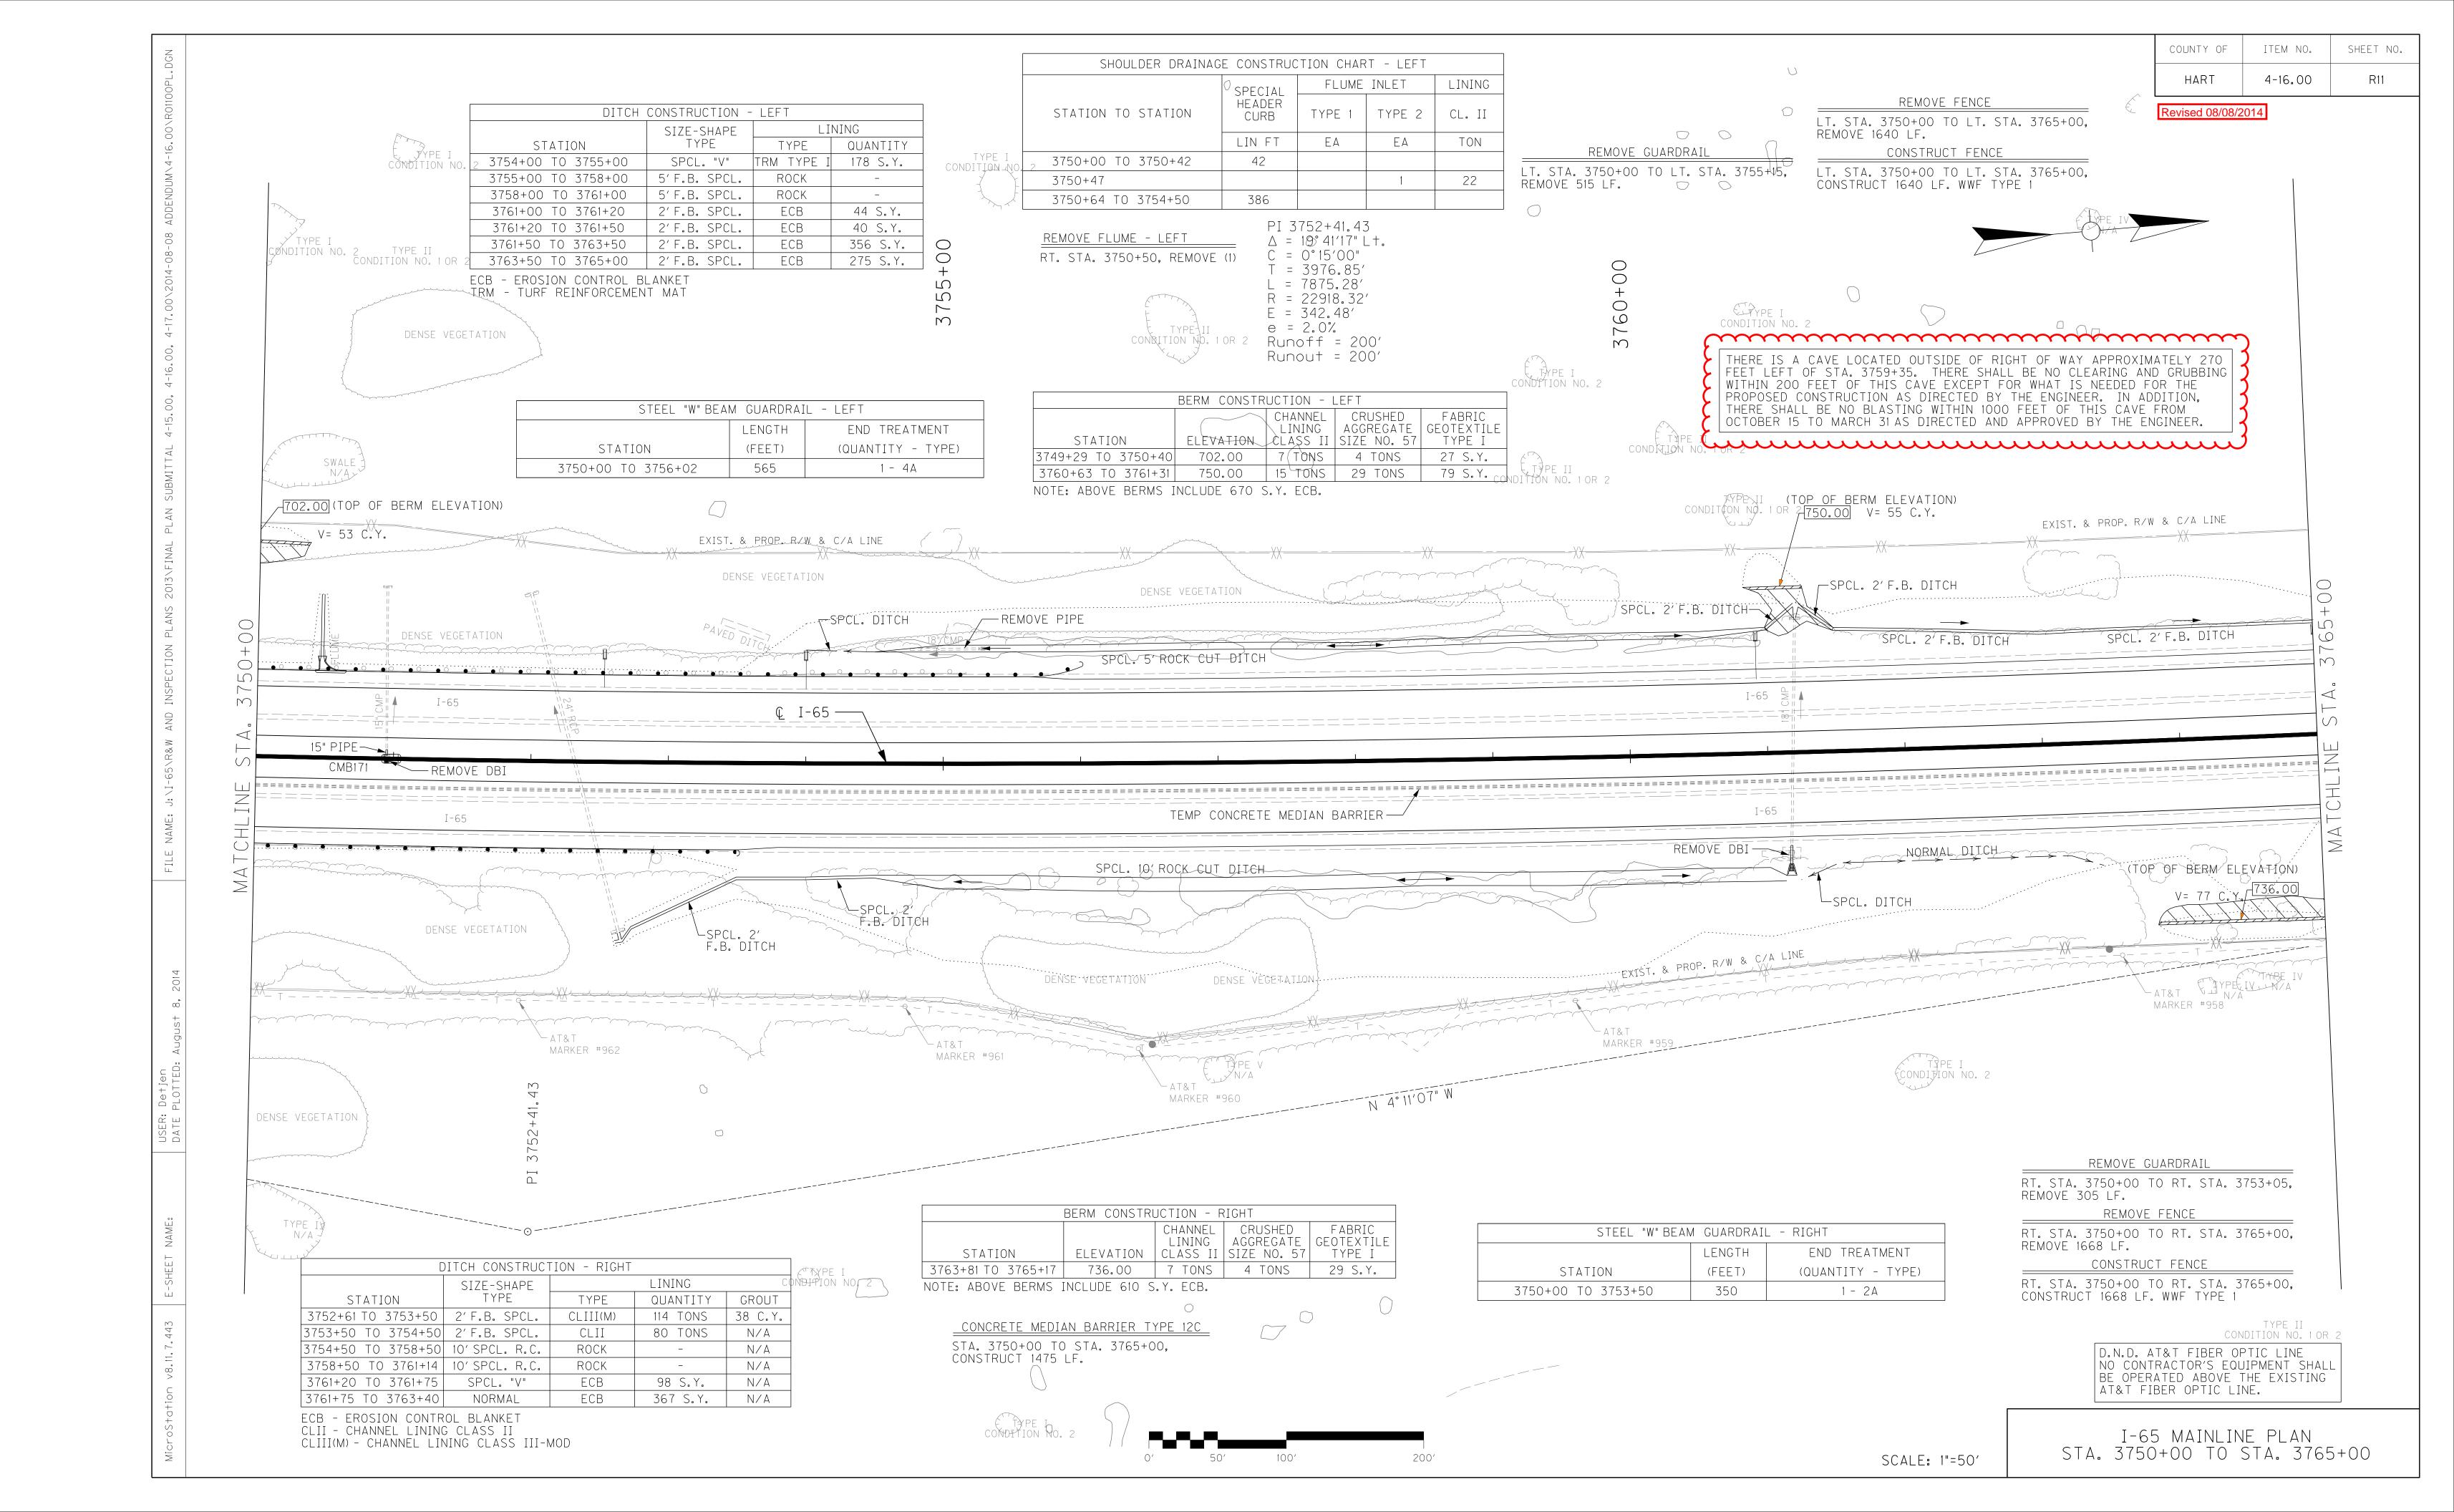

SHEET NO. COUNTY OF ITEM NO. **REVISED 8-11-14** 8-926.00 PULASKI X14 RT. STA. 21+29.0 CONSTRUCT APPROACH (CHARLES ELGIN RD.) LT. STA. 21+09.9 RT. STA. 21+09.5 END GUARDRAIL END GUARDRAIL 00 950 2.00% 940 CONSTRUCT 930 EMBANKMENT BENCH COM 4.27 SQ FT COM 8.09 CU YDS 21+00 COM EMB BENCH 39.58 CU YDS
SOIL EMB 0.00 CU YDS
GRANULAR EMB 14.58 CU YDS COM EMB BENCH 26.58 SQ FT SOIL EMB 0.00 SQ FT GRANULAR EMB 8.48 SQ FT SOIL REFILL 0.00 CU YDS GRANULAR REFILL 39.58 CU YDS SOIL REFILL 0.00 SQ FT GRANULAR REFILL 26.58 SQ FT 950 1.85% 3.77% 4.00% 2.00% 940 +-----930 930 EMBANKMENT BENCH 920 COM 8.57 CU YDS
COM EMB BENCH 41.63 CU YDS
SOIL EMB 0.00 CU YDS
GRANULAR EMB 15.94 CU YDS COM 4.47 SQ FT 20+50 COM EMB BENCH 16.17 SQ FT SOIL EMB 0.00 SQ FT GRANULAR EMB 7.27 SQ FT SOIL REFILL 0.00 CU YDS GRANULAR REFILL 41.63 CU YDS SOIL REFILL 0.00 SQ FT GRANULAR REFILL 16.17 SQ FT 941.49 940.35 00 11.00 14.00 15.72 950 4.00% 2.00% 0.11% 0.Щ% 940 940 930 930 CONSTRUCT EMBANKMENT BENCH 920 SOIL REFILL 0.00 CU YDS COM 4.79 SQ FT SOIL EMB 0.00 CU YDS GRANULAR EMB 27.53 CU YDS COM 8.57 CU YDS 20+00 COM EMB BENCH 28.79 SQ FT GRANULAR REFILL 55.05 CU YDS COM EMB BENCH 55.05 CU YDS SOIL EMB 0.00 SQ FT SCALE: 1" = 10' HORIZONTAL GRANULAR EMB 9.94 SQ FT 1" = 10' VERTICAL KY 70 STA.20+00 TO STA.21+00 SOIL REFILL 0.00 SQ FT GRANULAR REFILL 28.79 SQ FT

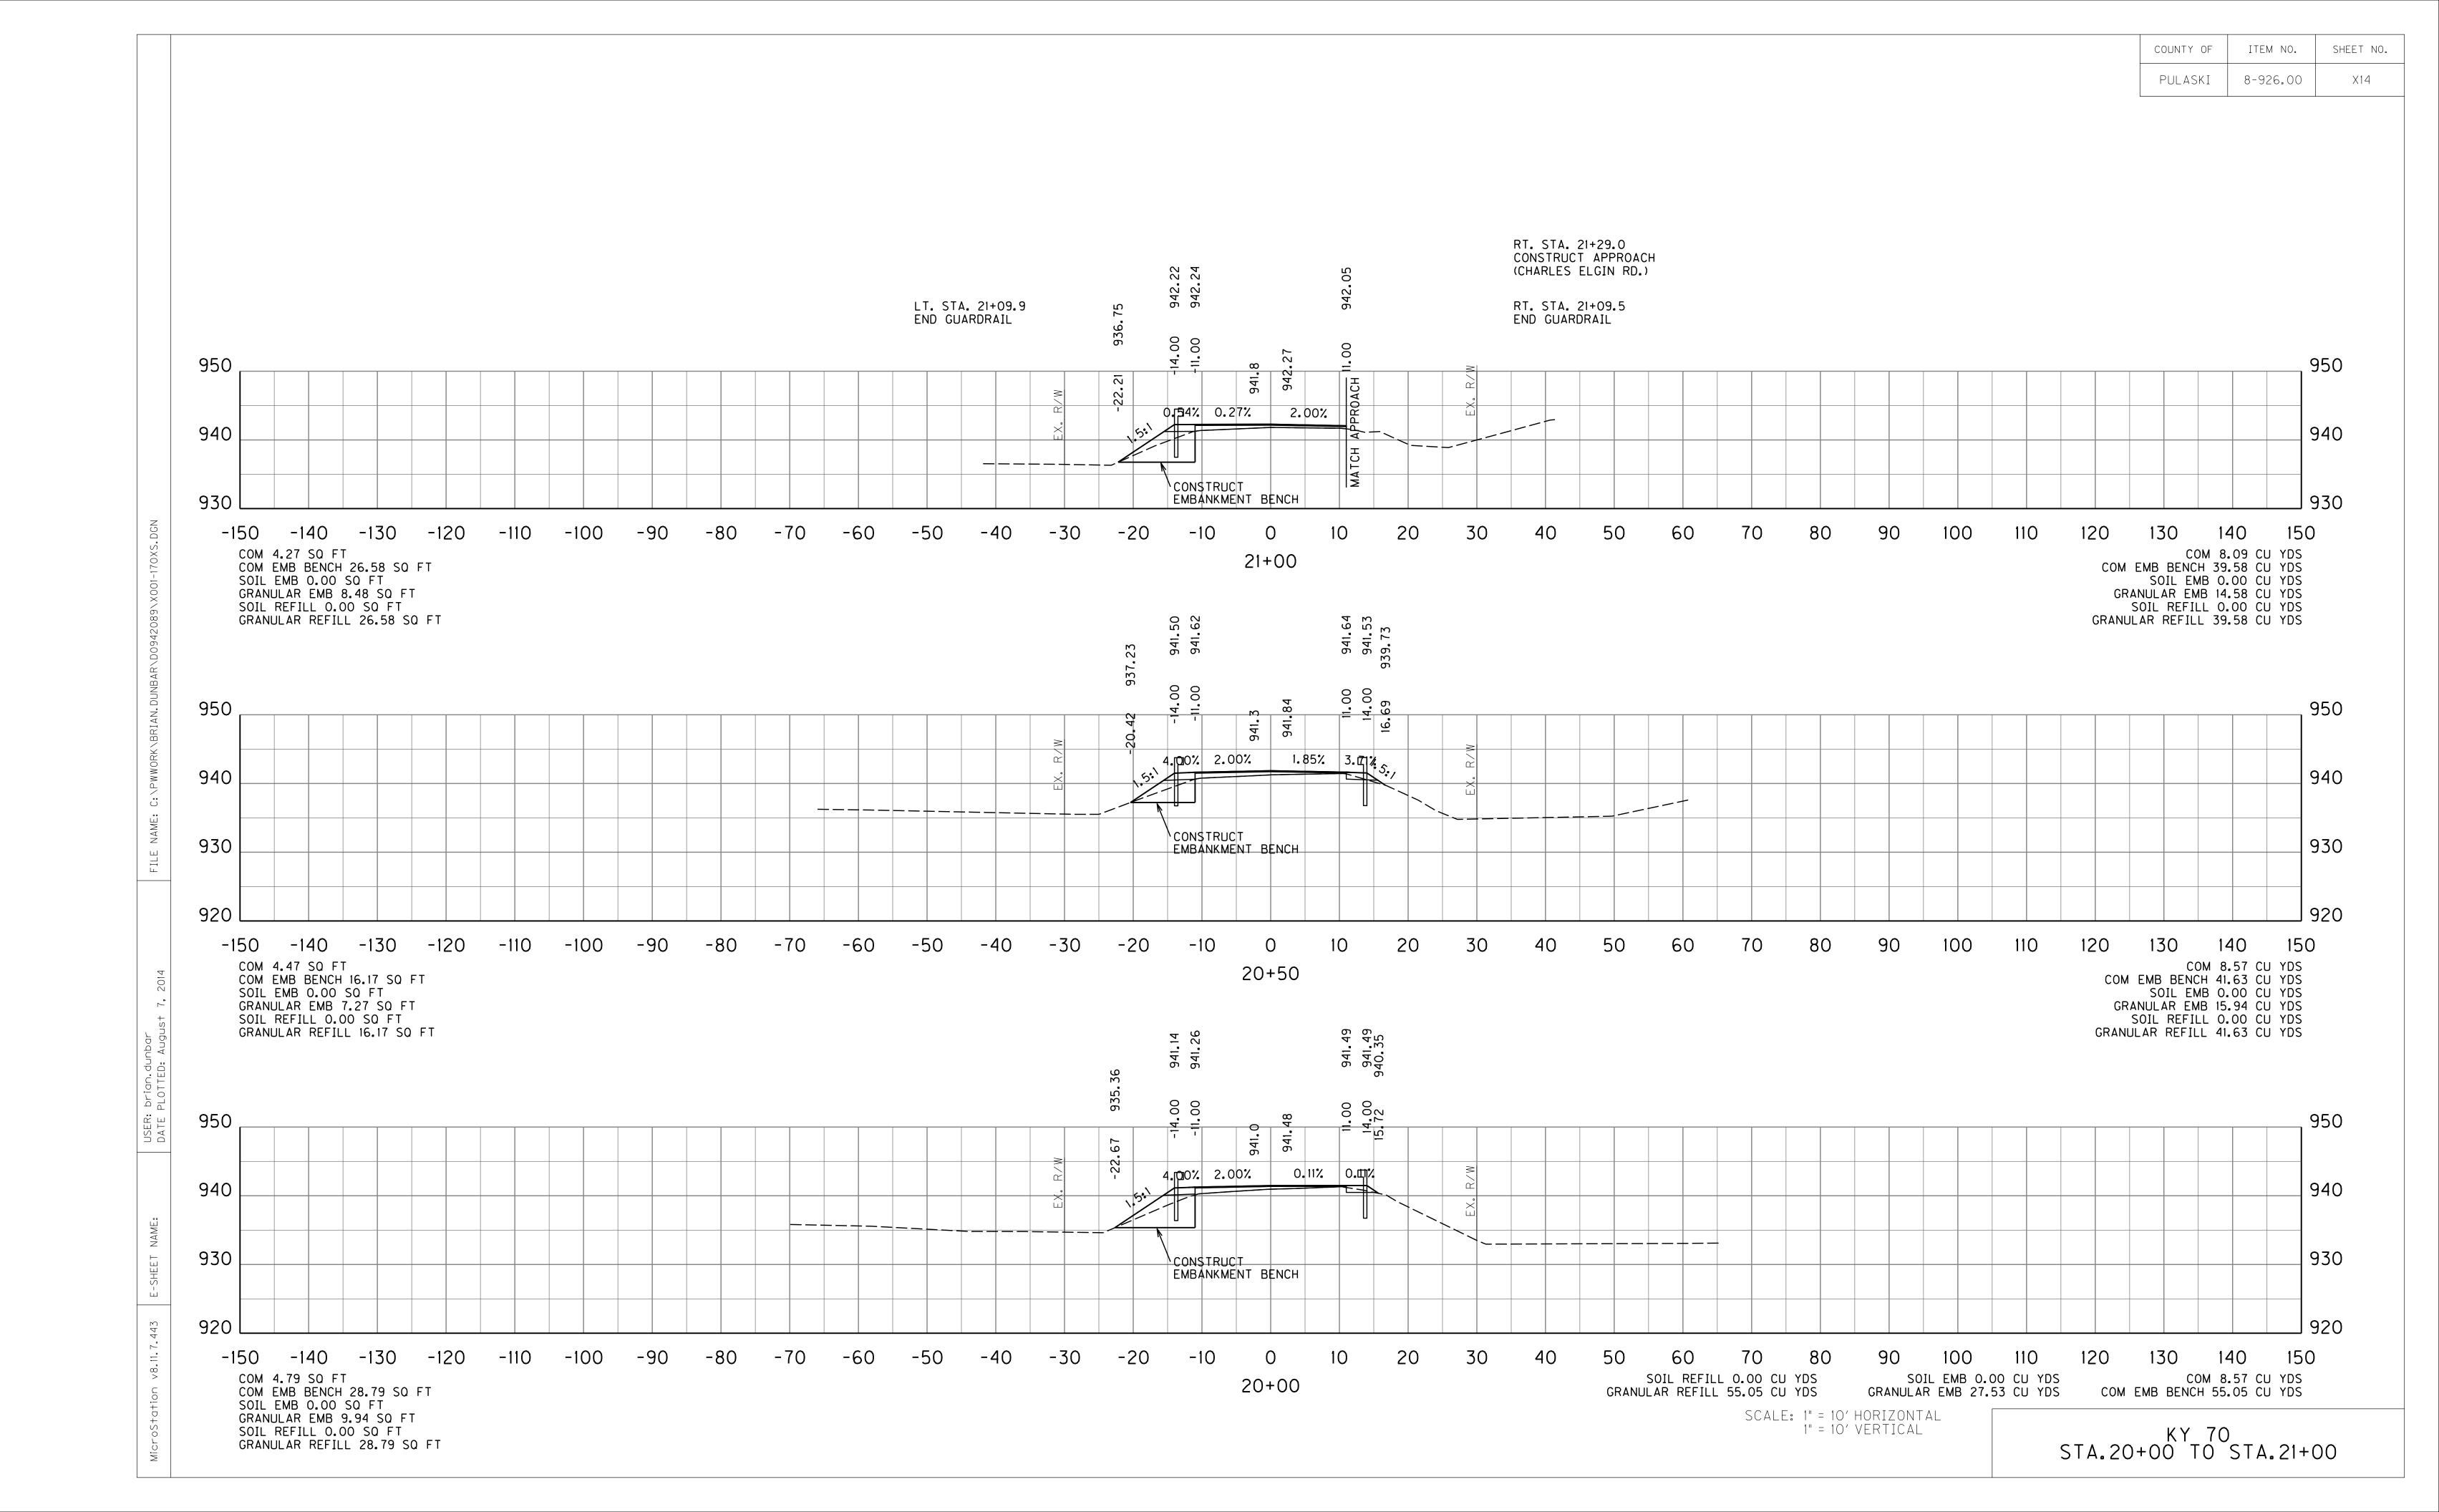

#### Special Note For: Erosion Prevention and Sediment Control Item No. 08 – 926.00 – Pulaski County

The Contractor shall be responsible for filing the Kentucky Pollution Discharge Elimination System (KPDES) KYR10 permit Notice of Intent (NOI) with the Kentucky Division of Water (DOW) and any KPDES local Municipal Separate Storm Sewer System (MS4) program that has jurisdiction. The NOI shall name the contractor as the Facility Operator and include the KYTC Contract ID Number (CID) for reference.

The Contractor shall perform all temporary erosion/sediment control functions including: providing a Best Management Practice (BMP) Plan, conducting required inspections, modifying the BMP plan documents as construction progresses and documenting the installation and maintenance of BMPs in conformance with the KPDES KYR10 permit effective on August 1, 2009 or a permit re-issued to replace that KYR10 permit. This work shall be conducted in conformance with the requirements of Section 213 of KYTC 2008 Department of Highways, Standard Specifications for Road and Bridge Construction.

Contrary to Section 213.03.03, paragraph 2, the Engineer shall conduct inspections as needed to verify compliance with Section 213 of KYTC 2008 Department of Highways, Standard Specifications for Road and Bridge Construction. The Engineer's inspections shall be performed a minimum of once per month and within seven days after a storm of ½ inch or greater. Copies of the Engineer's inspections shall not be provided to the contractor unless improvements to the BMP's are required. The contractor shall initiate corrective action within 24 hours of any reported deficiency and complete the work within 5 days. The Engineer shall use Form TC 63-61 A for this report. Inspections performed by the Engineer do not relieve the Contractor of any responsibility for compliance with the KPDES permit.

Contrary to Section 213.05, bid items for temporary BMPs will not be listed and will be replaced with one lump sum item for the services. Payment will be pro-rated based on the Project Schedule as submitted by the Contractor and as agreed to by the Engineer.

The contractor shall be responsible for applying "good engineering practices" as required by the KPDES permit. The contractor may use any temporary BMPs with the approval of the KYTC Engineer.

The contractor shall provide the Engineer copies of all documents required by the KPDES permit at the time they are prepared.

The contractor shall be responsible for the examination of the soils to be encountered and make his own independent determination of the temporary BMPs that will be required to accomplish effective erosion prevention and sediment control.

The Contractor shall be responsible for filing the KPDES permit Notice of Termination (NOT) with the Kentucky DOW and any local MS4 program that has jurisdiction. The NOT shall be filed after the Engineer agrees that the project is stabilized or the project has been formally accepted.

#### Special Note for Enhanced Sediment Control Measures Pulaski County / Item No 08-0926 Station 18 + 82.27

In addition to the previous special note regarding erosion prevention and sediment controls, a special note regarding specific sediment controls is now necessary. A temporary silt trap type B will be installed within the unnamed tributary of Buck Creek (Outstanding State Resource Water) at the downstream end of the culvert extension area located at Station 18 + 82.27. This measure will be used to retain sediment generated as a result of the culvert extension and will minimize the downstream transport of sediment. Following completion of construction, the silt trap will be removed and the area will be returned to pre-construction contours.

These enhanced sediment control measures are in cooperation with the Minimization and Mitigation Measures proposed in KYTC's Biological Assessment Report, Kentucky Highway 70 Safety Improvements Project, Pulaski County, completed June 2014. The United States Fish and Wildlife Service agreed to our proposed terms and conditions on July 28, 2014. In addition to the installation of a silt trap type B, the following sediment controls were to be implemented:

- The location of the individual erosion prevention/sediment control measures will be identified by the resident engineer and contractor.
- Mulch will be placed, during grade and drain activities, across all areas where no work will be conducted for a period of 14 consecutive days.
- Tree clearing within the riparian zone will be minimized. Trees to be removed will be determined
  by the resident engineer and the contractor prior to disturbance.
- Silt fence, or other approved method as appropriate, will be installed at the edge of waters within
  the project area to eliminate the deposition of rock and debris in the stream during construction
  activities. In the unforeseen event that unintended debris does enter the stream, the resident
  engineer will halt the contributing activity until appropriate remedial actions have been
  implemented.
- To the maximum extent plausible, construction activities will take place during low-flow periods.
- Equipment staging and cleaning areas will be located to eliminate direct inputs to waters of the Commonwealth. These areas will be located such that effluent will be filtered through vegetated areas and appropriate sediment controls prior to discharge offsite.
- Concrete will be poured in a manner to avoid spills into the stream. In the unforeseen event that a spill does occur, the USFWS will be notified, and the resident engineer will immediately halt the activity until remedial measures have been implemented.
- KYTC proposes to stabilize areas disturbed during construction activities through vegetation
  establishment and placement of riprap and geotextile fabric. Re-vegetation of the disturbed areas
  will allow thermoregulation of water within the stream, establish long-term, regenerative
  stabilization of the stream bank, and provide nutrients to the aquatic macroinvertebrate
  community through inputs of organic material.
- Areas disturbed during construction and not stabilized with rip rap and erosion blanket will be seeded using a standard seed mix. Depending on project slope and project location, application rates will vary and one of the following seed mix types will be used:
  - Seed Mix Type I: 30% Kentucky 31 tall fescue (Festuca arundinacea), 20% creeping red fescue (Festuca rubra), 35% hard fescue (Festuca longifolia), 10% perennial ryegrass (Lolium perenne), and 5% white Dutch clover (Trifolium repens).

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- O Seed Mix Type II: 60% Kentucky 31 tall fescue, 20% perennial ryegrass, 10% (based on pure live seed) little bluestem (*Schizachyrium scoparium*), and 10% partridge pea (*Cassia fasciculate*).
- o Seed Mix Type III: 40% Kentucky 31 tall fescue, 15% perennial ryegrass, 20% sericea lespedeza (*Lespedeza cuneata*), 15% partridge pea, and 10% (based on pure live seed) little bluestem.

Generally, these terms can be found in the KPDES KR10 permit dated June 29, 2009 and under section 212 and 213 of the KYTC Standard Specifications dated June 15, 2012. For the purpose of this project, they are reiterated above.

Additionally, the contractor is not responsible for the NOI. D8 has obtained the permit.

141041

#### **PROPOSAL BID ITEMS**

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Report Date 8/11/14

Section: 0001 - PAVING

LINE	BID CODE	ALT	DESCRIPTION	QUANTITY	UNIT	UNIT PRICEFP	<b>AMOUNT</b>
0010	00001		DGA BASE	1,518.00	TON	\$	
0020	00100		ASPHALT SEAL AGGREGATE	37.00	TON	\$	
0030	00103		ASPHALT SEAL COAT	5.00	TON	\$	
0040	00190		LEVELING & WEDGING PG64-22	824.00	TON	\$	
0050	00221		CL2 ASPH BASE 0.75D PG64-22	169.00	TON	\$	
0060	00301		CL2 ASPH SURF 0.38D PG64-22	405.00	TON	\$	
0070	02676		MOBILIZATION FOR MILL & TEXT	1.00	LS	\$	
0800	02677		ASPHALT PAVE MILLING & TEXTURING	26.00	TON	\$	

Section: 0002 - ROADWAY

LINE	BID CODE	ALT DESCRIPTION	QUANTITY	UNIT	UNIT PRICEFP	AMOUNT
		DELINEATOR FOR GUARDRAIL BI				
0090	01987	DIRECTIONAL WHITE		EACH	· · · · · · · · · · · · · · · · · · ·	
0100	02200	ROADWAY EXCAVATION	2,709.00	CUYD	· · · · · · · · · · · · · · · · · · ·	
0110	02223	GRANULAR EMBANKMENT	2,933.00	CUYD	\$	
0120	02360	GUARDRAIL TERMINAL SECTION NO 1	6.00	EACH	\$	
0130	02367	<b>GUARDRAIL END TREATMENT TYPE 1</b>	2.00	EACH	\$	
0140	02381	REMOVE GUARDRAIL	2,113.00	LF	\$	
0150	02545	CLEARING AND GRUBBING 0.1 ACRES	1.00	LS	\$	
0160	02562	TEMPORARY SIGNS	153.00	SQFT	\$	
0170	02600	FABRIC GEOTEXTILE TY IV FOR PIPE	100.00	SQYD	\$2.00 \$	\$200.0
0180	02650	MAINTAIN & CONTROL TRAFFIC	1.00	LS	\$	
0190	02671	PORTABLE CHANGEABLE MESSAGE SIGN	2.00	EACH	\$	
0200	02726	STAKING	1.00	LS	\$	
0210	05950	EROSION CONTROL BLANKET	500.00	SQYD	\$	
0220	05963	INITIAL FERTILIZER	.02	TON	\$	
0230	05964	20-10-10 FERTILIZER	.50	TON	\$	
0240	05985	SEEDING AND PROTECTION	10,000.00	SQYD	\$	
0250	05992	AGRICULTURAL LIMESTONE	.30	TON	\$	
0260	06510	PAVE STRIPING-TEMP PAINT-4 IN	4,000.00	LF	\$	
0270	06514	PAVE STRIPING-PERM PAINT-4 IN	8,000.00	LF	\$	
0280	20458ES403	CENTERLINE RUMBLE STRIPS	2,000.00	LF	\$	
0300	23143ED	KPDES PERMIT AND TEMP EROSION CONTROL	1.00	LS	\$	
0301	02351	GUARDRAIL-STEEL W BEAM-S FACE ADDED: 8-11-14	2,662.50	LF		
0302	02399	EXTRA LENGTH GUARDRAIL POST ADDED: 8-11-14		EACH		
0303	02704	SILT TRAP TYPE B ADDED: 8-11-14	1.00	EACH		

Section: 0003 - DRAINAGE

LINE	BID CODE	ALT DESCRIPTION	QUANTITY	UNIT	UNIT PRICEFP	AMOUNT
0310	00462	CULVERT PIPE-18 IN	71.00	LF	\$	

141041

#### **PROPOSAL BID ITEMS**

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Report Date 8/11/14

LINE	BID CODE	ALT DESCRIPTION	QUANTITY	UNIT	UNIT PRICEFP AMOUNT
0320	01450	S & F BOX INLET-OUTLET-18 IN	2.00	EACH	\$

Section: 0004 - BRIDGE

LINE	BID CODE	ALT	DESCRIPTION	QUANTITY	UNIT	UNIT PRICEFP	<b>AMOUNT</b>
0330	02625		REMOVE HEADWALL	1.00	EACH	\$	
0340	08002		STRUCTURE EXCAV-SOLID ROCK	13.00	CUYD	\$	
0350	08003		FOUNDATION PREPARATION	1.00	LS	\$	
0360	08100		CONCRETE-CLASS A	31.60	CUYD	\$	
0370	08150		STEEL REINFORCEMENT	3,134.00	LB	\$	

#### Section: 0005 - DEMOBILIZATION &/OR MOBILIZATION

LINE	BID CODE	ALT	DESCRIPTION	QUANTITY	UNIT	UNIT PRICE	FP AMOUNT
0380	02569		DEMOBILIZATION	1.00	LS	1	\$